

Riley Purgatory Bluff Creek Watershed District Permit Application Review

Permit No: 2024-005

Considered at Board of Managers Meeting: March 13, 2024

Received complete: February 19, 2024

Applicant: City of Chanhausen

Consultant: SEH Inc., Jen Desrude, PE

Project: Lake Ann Preserve and Park Improvements – The proposed project includes the reconstruction and expansion of the Greenwood Shores Park parking lot and the construction of bituminous trails and three boardwalk crossings. The applicant proposes two infiltration basins and one biofiltration basin to provide stormwater rate control, volume abstraction, and water quality control.

Location: Lake Ann Park Preserve, Chanhausen, MN

Reviewer: Annie Brunton, EIT and Scott Sobiech, PE, Barr Engineering

Proposed Board Action

Manager _____ moved and Manager _____ seconded adoption of the following resolutions based on the permit report that follows and the presentation of the matter at the March 13, 2024 meeting of the managers. Resolved that the application for Permit 2024-005 is approved, subject to the conditions and stipulations set forth in the Recommendations section of the attached report;

Resolved that on determination by the RPBCWD administrator that the conditions of approval have been affirmatively resolved, the RPBCWD president or administrator is authorized and directed to sign and deliver Permit 2024-005 to the applicant on behalf of RPBCWD.

Upon vote, the resolutions were adopted, _____ [VOTE TALLY].


Rule Conformance Summary

Rule	Issue	Conforms to RBPCWD Rules?	Comments
B	Floodplain Management and Drainage Alterations	Yes	
C	Erosion Control Plan	Yes	
D	Wetland and Creek Buffer	See Comment	See Rule Specific Permit Condition D1 related to executing the maintenance agreement and stipulation 6 requiring additional buffer monuments.
G	Waterbody Crossing and Structures	See Comment	See Rule Specific Permit Condition G1 related to executing the maintenance agreement.
J	Stormwater Management	Rate	Yes
		Volume	See Comment

Rule	Issue	Conforms to RBPCWD Rules?	Comments
	Water Quality	Yes	
	Low Floor Elev.	Yes	
	Maintenance	Yes	
	Chloride Management	Yes	See stipulation 4 related to providing a completed chloride management plan
	Wetland Protection	NA	
L	Permit Fee	NA	Governmental Entity
M	Financial Assurance	NA	Governmental Entity

Project Background

Lake Ann Preserve Park surrounds Lake Ann and a portion of Lake Lucy. The existing park is primarily woodland or wetland with stretches of pedestrian trails adjacent to the neighboring residential developments. The city is proposing to reconstruct and expand the Greenwood Shores Park parking lot and add approximately 7,900 feet of 10 foot-wide bituminous trails and three boardwalk crossings (two through Wetland 1 and one over the watercourse connecting Lake Lucy and Lake Ann). The applicant will construct two infiltration basins and a biofiltration basin to provide rate control, volume abstraction, and water quality control. The following figure illustrates the onsite and downgradient resources, and the table describes impact to the onsite and downgradient water resources .

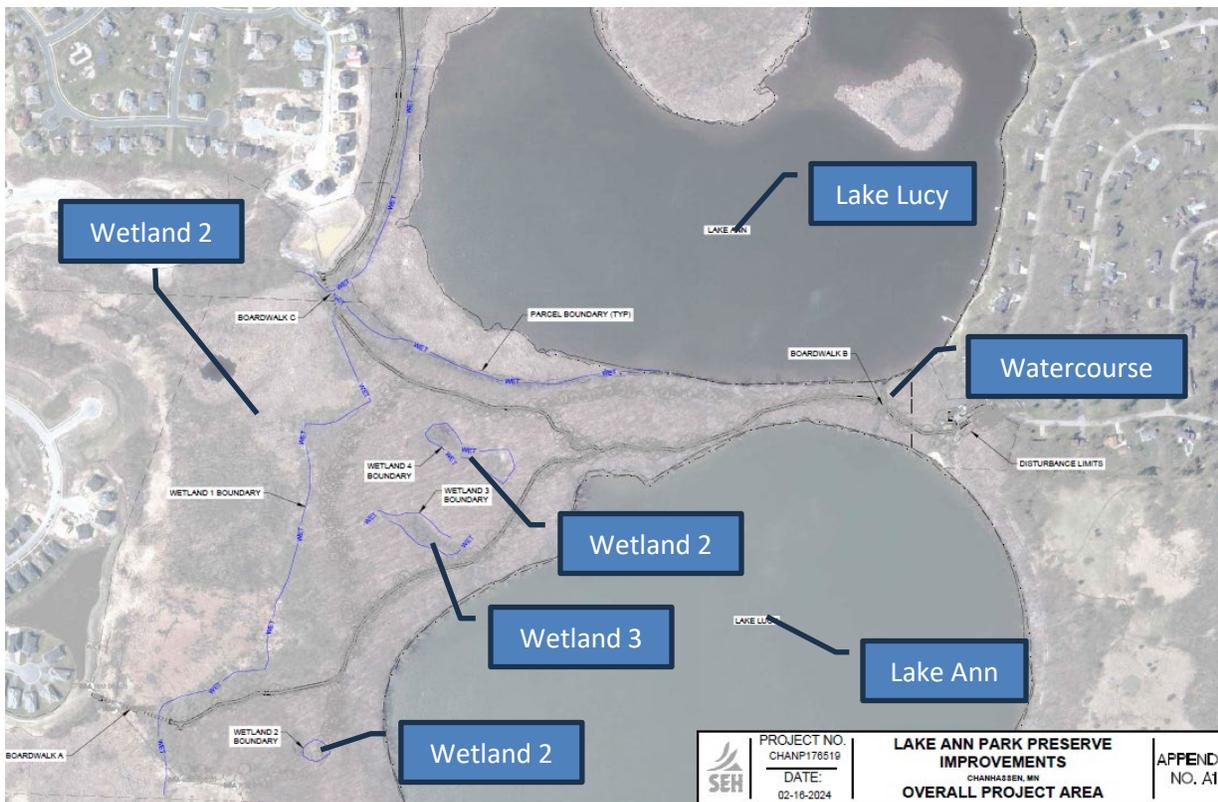

Water resource impacted by proposed project

Water Resource	Projected resource impacts
Wetland 1	An on-site, exceptional value Public Water Wetland (10021100-W) disturbed by proposed land-disturbing activities to construct Boardwalks A and C
Wetland 2	An on-site, wetland downgradient of the proposed land-disturbing activities.
Wetland 3	An on-site, wetland downgradient of the proposed land-disturbing activities.
Wetland 4	An on-site, wetland downgradient of the proposed land-disturbing activities.
Lake Lucy	Public water that receives site discharge
Lake Ann	Public Water receives site discharge
Watercourse	A Public Water watercourse connecting Lake Lucy and Lake Ann. Boardwalk B spans this watercourse.

The project site information is summarized below:

Description	Total Area (acres)
Total Site Area	111.56
Existing Site Impervious	1.17
Post-Construction Site Impervious	2.83
New (increase) in Impervious Area	1.66 (>100% increase)
Sidewalk and Trail Exempt Impervious Area (acres) ¹	2.62
New (increase) in Regulated Site Impervious Area	0.07 (6% increase)
Regulated Disturbed Impervious Surface	0.14 (12% disturbed)
Total Disturbed Area	3.74

¹The regulated area includes impervious surfaces in the Greenwood Park area at the eastern portion of the site. Impervious surfaces on the rest of the site include trails that are exempt from Rule J for Stormwater Management.

Exhibits:

1. Permit Application received January 17, 2024 (applicant was notified of an incomplete application on February 5, 2024; information completing the application was received on February 19, 2024)
2. Stormwater Management Report narrative dated January 17, 2024 (revisions dated February 16, 2024, February 26, 2024, and March 4, 2024)
3. Soil boring logs dated December 20, 2023
4. FEMA Floodplain Maps (Effective December 31, 2023) and RPBCWD Floodplain Maps
5. Wetland Delineation Report prepared by SEH dated October 13, 2022
6. Wetland Permitting Memorandum dated January 11, 2024
7. Wetland Delineation Results dated September 29, 2022
8. Design Plans Sheets dated December 20, 2024 (revisions submitted February 19, 2024, February 26, 2024, and March 4, 2024)
9. Existing and Proposed Conditions HydroCAD Model for 2-, 10-, and 100-year, and 100-year snowmelt events received January 17, 2024 (revisions submitted February 19, 2024 and February 26, 2024)

10. Existing and Proposed Conditions P8 Model received January 17, 2024 (revision submitted February 19, 2024)
11. MN DNR Work in Waters Permit 2023-2932 dated November 9, 2023
12. Response to February 5, 2024 RPBCWD Comments on February 15, 2024 and February 19, 2024.
13. Response to February 21, 2024 RPBCWD Comments on February 26, 2024
14. Response to comments received on March 4, 2024
15. Draft Chloride Management Plan submitted February 19, 2024
16. Operation and Maintenance Agreement dated February 16, 2024 (revision submitted February 26, 2024 and March 6, 2024)
17. Smart Salt Certifications submitted February 19, 2024

Rule Specific Permit Conditions

Rule B: Floodplain Management and Drainage Alterations

Because the project disturbs land below the 100-year flood elevation of Wetland 1 to install the helical piers for Boardwalks A and C, the project must conform to the requirements in the RPBCWD Floodplain Management and Drainage Alteration rule (Rule B, Subsection 2.1). Boardwalk B spans the 100-year floodplain adjacent to the watercourse between Lake Lucy and Lake Ann and no disturbance or no fill is proposed in the floodplain; therefore Boardwalk B does not trigger Rule B.¹

The proposed Boardwalk A and C construction conforms to Rule B, Subsections 3.1 because no buildings are proposed to be constructed or reconstructed as part of the project. Placement of fill below the 100-year flood elevation is prohibited unless fully compensatory storage at or below the same elevation for fill in the floodplain of a water basin and within the floodplain of the same waterbody is provided (Rule B, Subsection 3.2). The applicant proposes to place 0.11 cubic yards of fill below the 100-year floodplain of Wetland 1 for the construction of Boardwalk A and C and provide 0.8 cubic yards of compensatory storage. Because the project will provide a net increase in compensatory floodplain storage of 0.69 cubic yards in Wetland 1 at the same elevation, the proposed project conforms to Rule B, Section 3.2.

The applicant will provide compensatory storage volumes within the floodplain and does not propose to impact the wetland, thus demonstrating the project is unlikely to impact flood risk or adversely affect channel stability. Because the boardwalk crossings maintain identical hydraulic configuration to existing

¹ The work for constructing boardwalks within Wetland 1 appears to trigger state regulatory requirements administered by the Department of Natural Resources (i.e., require a Work in Public Waters permit). It is the applicant's responsibility to determine whether an RPBCWD permit for the work, if granted, provides the necessary DNR approval under DNR General Permit 2015-1192, issued for projects permitted by RPBCWD.

conditions for the 100-year event, the project is unlikely to adversely affect groundwater hydrology, stream base flow, or water quality consistent with the criteria in Rule B, Subsection 3.3. Because the applicant proposes boardwalks with minimal disturbance of the bed of the waterbody, wildlife will continue to be able to traverse under and around boardwalks similar to existing conditions, thus preserving wildlife habitat, thus consistent with Rule B, Subsection 3.3.

The proposed project conforms to the floodplain management and drainage alteration requirements of Rule B.

Rule C: Erosion and Sediment Control

Because the project will involve 3.74 acres of land-disturbing activities, the project must conform to the requirements in the RPBCWD Erosion and Sediment Control rule (Rule C, Subsection 2.1).

The erosion control/turf restoration plan includes installation of biolog, rock construction entrances, turf establishment, daily inspection, placement of a minimum of 6 inches of topsoil with 5 percent organic matter, minimization of compaction during construction, and retention of native topsoil onsite. The applicant identified Joe Seidl (jseidl@chanhassenmn.gov; PH. 952.227.1168) as the person responsible for erosion prevention and sediment control during construction.

The proposed project conforms to the erosion and sediment control requirements of Rule C.

Rule D: Wetland and Creek Buffers

Because the proposed work triggers RPBCWD Rule B, G, and J and the applicant proposes disturbance in the public waters wetland onsite (Wetland 1), land-disturbing activities upgradient from Wetland 2, Wetland 3 and Wetland 4, Rule D, Subsection 2.1a requires the applicant to establish buffer areas. Subsection 3.1b requires buffer on the edges of Wetlands 2, 3, and 4 downgradient from the land-disturbing activities. Because the boardwalk construction activities constitute a disturbance of Wetland 1, wetland buffer must be provided around the entire wetland on the property owned by the applicant (Rule D, subsection 3.1a). Because the applicant also proposes land-disturbing activities upgradient from the public waters watercourse between Lake Lucy and Lake Ann, Rule D, Subsections 2.1a and 3.1c requires buffer adjacent to this watercourse and 50 feet each from the upstream and downstream extents of disturbance.

Because the applicant elected to presume the wetlands were all exceptional value, an average buffer width of 80 feet and a minimum buffer width of 40 feet is required in accordance with Rule D, Subsection 3.2.b.i. The public waters watercourse between Lake Lucy and Lake Ann flows through the project site and requires an average buffer width of 50 feet from the creek centerline, minimum 30 feet in accordance with Rule D, Subsection 3.2.b.v. The buffer widths are summarized in the following table:

Wetland Buffer Summary

Wetland ID	RPBCWD Wetland Value	Required Minimum Width ¹ (ft)	Required Average Width ¹ (ft)	Provided Minimum Width (ft)	Provided Average Width (ft)
Wetland 1	Exceptional ²	40	80	40	88.8
Wetland 2	Exceptional ²	40	80	80	81.0
Wetland 3	Exceptional ²	40	80	40	80.2
Wetland 4	Exceptional ²	40	80	80	80.8
Watercourse	NA	30	50	50	50

¹ Average and minimum required buffer width under Rule D, Subsection 3.1.a.

² Assumed.

Because the project plans indicate the applicant will maintain more than 50 feet adjacent to the public waters watercourse between Lake Lucy and Lake Ann in a natural condition, the project conforms to Rule D, Subsection 3.2.b.v. While the Applicant provided buffer zone and wetland buffer marker location information in a wetland permitting memorandum in conformance with Rule D, Subsection 3.4, buffer monumentation is required for the public waters watercourse. The buffer monument locations and detail are also provided in the construction drawings. The erosion control plan requires revegetating disturbed areas within the proposed buffer with native vegetation, which conforms with Rule D, Subsection 3.3. A note is included on the plan sheet indicating the project will be constructed so as to minimize the potential transfer of aquatic invasive species (e.g., zebra mussels, Eurasian watermilfoil, etc.) to the maximum extent possible conforming to Rule D, Subsection 3.6.

Buffer areas and maintenance requirements must be documented in an agreement after review and approval by RPBCWD in accordance with Rule D, Subsection 3.5. While the applicant provided a draft maintenance agreement for review that aligns with RPBCWD requirements, the following revision is needed:

D1. The applicant must provide RPBCWD an executed version.

Rule G: Waterbody Crossings and Structures

Because the project will construct two waterbody crossings (Boardwalks A and C) in contact with the banks of Wetland 1 (a public water wetland) and a third crossing (Boardwalk B) over the watercourse between Lake Ann and Lake Lucy, the project must conform to all applicable criteria in RPBCWD's Rule G - Waterbody Crossing and Structures. Because the applicant obtained a Minnesota Department of Natural Resources Public Waters permit, permit 2023-2932, for the proposed work at Boardwalk B, work in the watercourse between Lake Lucy and Lake Ann is exempt from the requirements of Rule G in accordance with Rule G, Subsection 2.1.

The construction of Boardwalk A and Boardwalk C work represents a public benefit by connecting the preserve's eastern and western recreation paths across Wetland 1, thus increasing public access to the preserve area and Greenwood Shores Park (Rule G, subsection 3.1a).

The applicant proposes several helical piers within the floodplain of Wetland 1 to support the Boardwalk A and C crossings. Because each helical pier is less than 3 inches in diameter, the RPCBWD engineer concurs with the applicant's use of the hydraulic cross-sectional area as a surrogate for demonstrating hydraulic capacity maintenance instead of developing computer modeling. The reduction in cross-sectional flow area is 2 square feet (1.4%) at Boardwalk A and 1.6 square feet (1.3%) at Boardwalk C. Because the drawings demonstrate the project will create an equivalent cross-sectional area of flow for the 100-year event at Boardwalks A and C, the engineer concurs the project will maintain hydraulic capacity and the project conforms with Rule G, Subsection 3.2a

The waterbodies are not used for navigation, so Rule G, Subsection 3.2b does not impose any requirements on the project. As was demonstrated for compliance with Rule B, Subsection 3.3, the compensatory storage and channel cross sectional area information provided demonstrate that the project is unlikely to adversely affect water flow and thus is not reasonably likely to cause increased scour, erosion, sedimentation, or water quality impacts consistent with the criteria in Rule G, Subsection 3.2c. Because the proposed crossings maintain a similar cross-sectional area as in existing conditions, wildlife will continue to be able to use the crossing as it is used under existing conditions, thus preserving wildlife passage, thus consistent with Rule G, Subsection 3.2d.

A no-build option of the waterbody crossings would not achieve the public benefit of connecting the portions of the park; all that could be achieved without crossings would be a trail loop to and from the southwest resident access point and a path from the northwest residential access point to Lake Lucy Road. Neither of these trails provide public parking, access to Greenwood Shores Park, nor would they meet the project's goal of increasing access to the preserve. Alternatively, paving the trail connections was also considered but not pursued given that this would result in larger impacts to Wetland 1 and fill in the floodplain. Culverts would be required to maintain adequate hydraulic capacity and would have a larger impact on wildlife passage between the waterbodies. The proposed option has the smallest impact to the surrounding wetlands which meets Rule G, Subsection 3.2e.

Since there is no construction nor improvement of an outfall structure in contact with the bed or bank of a waterbody, Rule G, Subsection 3.3 does not impose requirements on the project.

The SWPPP includes a note directing the contractor that no work affecting the bed water basin shall occur between April 1 and June 30 as required in Rule G, Subsection 3.7a. A note is included on the plan sheet indicating the project will be constructed so as to minimize the potential transfer of aquatic invasive species (e.g., zebra mussels, Eurasian watermilfoil, etc.) to the maximum extent possible (Rule G, Subsection 3.7c).

Rule G, Subsection 3.7d requires compliance with the applicable criteria in subsections 3.3 of Rule F. Because the construction drawings submitted confirm that no riprap is proposed in the bed or bank of the waterbody and that stabilization will be with native vegetation on slopes no steeper than 3:1 waterward of the ordinary high water level the proposed project conforms to subsection 3.3.7d.

The permit applicant provided a draft maintenance agreement for the waterbody crossing for RPBCWD approval, in accordance with Rule G, Section 5. While the applicant provided a draft maintenance agreement for review that aligns with RPBCWD requirements, the following revision is needed:

- G1. The applicant must provide RPBCWD an executed version.

Rule J: Stormwater Management

Because the project will alter 3.74 acres of land-surface area the project must meet the criteria of RPBCWD’s Stormwater Management rule (Rule J, Subsection 2.1). Because the applicant proposes to increase the imperviousness on the site by more than 50%, the criteria in section 3 apply to the entire site (Rule J, subsection 2.3). While the project results in a total of 2.83 acres of new and existing impervious surface on the site, 1.59 acres of new paved trail and 1.03 acres of existing paved trail are exempt from RPBCWD’s stormwater management rule (Rule J, Subsection 2.2d). Therefore, the requirements of Rule J apply to the 0.21 acres of regulated impervious surface on the site.

Rate Control

In order to meet the rate control criteria listed in Subsection 3.1.a, the 2-, 10-, and 100-year post-development peak runoff rates must be equal to or less than the existing discharge rates at all locations where stormwater leaves the site.

The applicant used HydroCAD to simulate runoff rates for pre- and post-development conditions for the 2-, 10-, and 100-year frequency storm events using a nested rainfall distribution, and a 100-year frequency, 10-day snowmelt event. The existing and proposed 2-, 10-, and 100-year frequency discharges from the site are summarized in Table 5. The proposed project is in conformance with RPBCWD Rule J, Subsection 3.1.a.

Rate control summary

Modeled Discharge Location	2-Year Discharge (cfs)		10-Year Discharge (cfs)		100-Year Discharge (cfs)		10-Day Snowmelt (cfs)	
	Ex	Prop	Ex	Prop	Ex	Prop	Ex	Prop
Lake Ann	0.4	0.3	1.0	0.9	2.5	2.5	0.1	0.10
Lake Lucy	0.1	0	0.3	0	0.7	0.6	<0.1	0

Volume Abstraction

Subsection 3.1b of Rule J requires the abstraction onsite of 1.1 inches of runoff from the regulated impervious surface of the site. An abstraction volume of 839 cubic feet is required from the 0.21 acres of regulated impervious area. Soil information from three soil borings collected by American Engineering Testing indicate the top 4 to 4.5 feet of soil is predominately silty sand and poorly-graded sand with some organic soils at the surface. Underlying soils showed sandy lean clay with gravel and evidence of redoximorphic soils via iron-staining. Groundwater was not encountered during the drier-than-normal conditions during the geotechnical investigation. The subsurface investigation information summarized in the table below supports a determination that groundwater is at least 3 feet below the bottom of the two northernmost proposed infiltration basins (Rule J, Subsection 3.1.b.2.a). Because adequate separation to the clay layer exhibiting redoximorphic conditions was achieved by the south basin, the basin is designed as a biofiltration basin.

BMP summary

Proposed BMP	Nearest Subsurface Investigation	Boring is within footprint?	Groundwater Elevation (feet) ¹	BMP Bottom Elevation (feet)	Separation (feet)
North infiltration basin	B-1	Yes	961.50	964.50	3.00
Center infiltration basin	B-3	Yes	961.50	964.50	3.00
South biofiltration basin	B-2	Yes	961.00	963.75	2.75

¹ Groundwater not encountered during drilling. The groundwater elevation is assumed to be the top horizon of iron-stained clay soil. Elevations estimated using known topography instead of the elevations provided by the soil borings.

Because the engineer concurs that the information showing low permeable soils (i.e., clay), high groundwater via the redoximorphic conditions, limited area in the natural tree-constrained area, and site topography support that the abstraction standard in subsection 3.2 of Rule J cannot practicably be met for runoff from the regulated impervious surface, the site is considered a restricted site and stormwater runoff volume must be managed in accordance with subsection 3.3 of Rule J.

For restricted sites, subsection 3.3 of Rule J requires rate control in accordance with subsection 3.1.a and that abstraction and water-quality protection be provided in accordance with the following sequence: (a) Abstraction of 0.55 inches of runoff from site impervious surface determined in accordance with paragraph 3.2, and treatment of all runoff to the standard in paragraph 3.1c; or (b) Abstraction of runoff onsite to the maximum extent practicable and treatment of all runoff to the standard in paragraph 3.1c; or (c) Off-site abstraction and treatment in the watershed to the standards in paragraph 3.1b and 3.1c. Because soils identified in the borings, high groundwater, and limited space

within the natural tree-constrained area, the abstraction standard in Subsection 3.3a of Rule J cannot practicably be achieved. The applicant incorporated infiltration to promote infiltration to the maximum extent practicable to conform to Rule J, subsection 3.3b.

The table below summarizes the volume abstraction for the site.

	Abstraction Depth (inches)	Abstraction Volume (cubic feet)
Requirement	1.1	839
Provided	0.34	371

The applicant has submitted soil borings indicating underlying clay soils and has indicated that soil infiltration testing will be completed this spring once conditions are appropriate. The engineer concurs with the applicant’s design infiltration rate of 0.06 inches per hour based on the soil borings provided by the geotechnical engineer and the guidelines provided in the MN Stormwater Manual. Based on the presumed design infiltration rate, the engineer concurs that the proposed infiltration systems will draw down within 48 hours (Rule J, subsection 3.1b.3). Per Rule J, Subsection 3.1.b.2.c measured infiltration capacity of the soils at the bottom of the infiltration systems must be provided. The applicant must submit documentation verifying the infiltration capacity of the soils and that the volume control capacity is calculated using the measured infiltration rate. If infiltration capacity is less than needed to conform with the volume abstraction requirement in subsection 3.3b or there is inadequate separation to groundwater or redoximorphic soils, the applicant will need to submit design modifications (in the form of an application for a permit modification or new permit) or demonstrate that the project is nonetheless still providing abstraction to the maximum extent practicable.

Water Quality Management

Subsection 3.1.c of Rule J requires the Applicant to provide for at least 60 percent annual removal efficiency for total phosphorus (TP), and at least 90 percent annual removal efficiency for total suspended solids (TSS), as well as no net increase in pollutant loading from existing conditions.

The applicant submitted P8 models to estimate the TP and TSS loading from the watersheds and the removal capacity of the proposed BMPs. The results of this modeling are summarized in the tables below. The results show the proposed project will remove sufficient TSS and TP to achieve an overall pollutant reduction in accordance with the required annual removals (Rule J, Subsection 3.2c).

Annual TSS and TP removal summary

Resource	Pollutant of Interest	Regulated Site Loading (lbs/yr)	Required Load Removal (lbs/yr) ¹	Provided Load Reduction (lbs/yr)
Lake Ann	Total Suspended Solids (TSS)	170	153 (90%)	154 (90%)
	Total Phosphorus (TP)	0.54	0.32 (60%)	0.39 (72%)
Lake Lucy	Total Suspended Solids (TSS)	0 ²	0	0
	Total Phosphorus (TP)	0	0	0

¹Required load reduction is calculated based on the criteria in Rule J, Subsection 3.1c and the new and reconstructed impervious area site loading.

² Because all flows less than and including the 10-year event are discharge to Lake Ann, only extreme event overflow would discharge to Lake Lucy .

Summary of net change in TSS and TP leaving the site

Resource	Pollutant of Interest	Existing Loading (lbs/yr)	Proposed Load after Treatment (lbs/yr)	Change (lbs/yr)
Lake Ann	Total Suspended Solids (TSS)	68	17	-51
	Total Phosphorus (TP)	0.21	0.15	-0.06
Lake Lucy	Total Suspended Solids (TSS)	30	0	-30
	Total Phosphorus (TP)	0.09	0	-0.09

Low floor Elevation

No structure may be constructed or reconstructed such that its lowest floor elevation is less than 2 feet above the 100-year event flood elevation according to Rule J, Subsection 3.6a. In addition, a stormwater-management facility must be constructed at an elevation that ensures that no adjacent habitable building will be brought into noncompliance with a standard in this subsection 3.6b. Because the project does not propose to construct or reconstruct structures that have low-floor elevations, subsection 3.6a does not impose requirements on the project. However, the project will construct stormwater management facilities south of the existing habitable structure at 7100 Utica Lane. The RPBCWD Engineer concurs with the low floor analysis provided by the applicant, which utilized Appendix J1, that demonstrates the proposed project is in conformance with Rule J, Subsection 3.6b.

Low Floor Evaluation of Existing Structures

Stormwater Facility	Low Floor Elevation of Building (feet)	100-year Event Flood Elevation of Adjacent Stormwater Facility (feet)	Freeboard (feet)
North infiltration basin	968.00	964.70	3.30

Maintenance

Subsection 3.7 of Rule J requires the submission of maintenance plan. All stormwater management structures and facilities must be designed for maintenance access and properly maintained in perpetuity to assure that they continue to function as designed. Permit applicant has provided a draft maintenance and inspection plan for review and approval by RPBCWD. While the applicant provided a draft maintenance agreement for review, the following revisions are needed:

- J1. The applicant must provide RPBCWD an executed version.

Chloride Management

Subsection 3.8 of Rule J requires the submission of chloride management plan that designates the individual authorized to implement the chloride management plan and the MPCA-certified salt applicator engaged in implementing the plan. The Permit applicant provided a draft chloride management plan that designates the individual authorized to implement the chloride management plan as Joe Seidl with the City of Chanhassen. The permit applicant must provide a signed chloride management plan with the attachments specific in the plan to confirm that Mr. Seidl is certified by the MPCA.

Wetland Protection

Because the proposed land-disturbing activities that discharge to the on-site protected Wetland 1, 2, 3 and 4 are exempt from stormwater management (Ruel J, subsection 2.2d), Rule J, subsection 3.10 does not impose requirements on the project.

Applicable General Requirements:

1. The RPBCWD Administrator and Engineer shall be notified at least three days prior to commencement of work.
2. Construction shall be consistent with the plans and specifications approved by the District as a part of the permitting process. The date of the approved plans and specifications is listed on the permit.
3. Construction must be consistent with the plans, specifications, and models that were submitted by the applicant that were the basis of permit approval. The date(s) of the approved plans, specifications, and modeling are listed above and on the permit. The granting of the permit does not in any way relieve the permittee, its engineer, or other professional consultants of responsibility for the permitted work.
4. The grant of the permit does not relieve the permittee of any responsibility to obtain approval of any other regulatory body with authority.
5. The issuance of this permit does not convey any rights to either real or personal property, or any exclusive privileges, nor does it authorize any injury to private property or any invasion of personal rights, nor any infringement of federal, state, or local laws or regulations.
6. In all cases where the doing by the permittee of anything authorized by this permit involves the taking, using or damaging of any property, rights or interests of any other person or persons, or of any publicly owned lands or improvements or interests, the permittee, before proceeding therewith, must acquire all necessary property rights and interest.
7. RPBCWD's determination to issue this permit was made in reliance on the information provided by the applicant. Any substantive change in the work affecting the nature and extent of applicability of RPBCWD regulatory requirements or substantive changes in the methods or means of compliance with RPBCWD regulatory requirements must be the subject of an application for a permit modification to the RPBCWD.

8. If the conditions herein are met and the permit is issued by RPBCWD, the applicant, by accepting the permit, grants access to the site of the work at all reasonable times during and after construction to authorized representatives of the RPBCWD for inspection of the work.

Findings

1. The proposed project includes the information necessary, plan sheets and erosion control plan for review.
2. The proposed project conforms to Rule B and C.
3. The proposed project will conform to Rules D, G and J if the conditions listed above are met.
4. Under Minnesota Department of Natural Resources General Permit 2015-1192 (attached to this report), approval of work under RPBCWD rule(s) G constitutes approval under applicable DNR work in waters rules. Compliance with conditions on approval and payment of applicable fees, if any, are necessary to benefit from general permit approval and the responsibility of the applicant. The work for constructing boardwalks within Wetland 1 appears to trigger state regulatory requirements administered by the Department of Natural Resources (i.e., require a Work in Public Waters permit). It is the applicant's responsibility to determine whether an RPBCWD permit for the work, if granted, provides the necessary DNR approval under DNR General Permit 2015-1192, issued for projects permitted by RPBCWD.

Recommendation:




Approval of the permit contingent upon:

1. Receipt of an executed maintenance and inspection agreement.

By accepting the permit, when issued, the applicant agrees to the following stipulations:

1. Continued compliance with General Requirements.
2. Per Rule J Subsection 5.6, upon completion of the site work, the permittee must submit as-built drawings demonstrating that at the time of final stabilization the stormwater management facilities conform to design specifications and functions as intended and approved by the District. As-built/record drawings must be signed by a professional engineer licensed in Minnesota and include, but not limited to:
 - a) the surveyed bottom elevations, water levels, and general topography of all facilities;
 - b) the size, type, and surveyed invert elevations of all stormwater facility inlets and outlets;
 - c) the surveyed elevations of all emergency overflows including stormwater facility, street, and other;
 - d) other important features to show that the project was constructed as approved by the Managers and protects the public health, welfare, and safety.
3. Providing the following additional close-out materials:
 - a) Documentation that constructed stormwater facilities perform as designed. This may include infiltration testing, flood testing, or other with prior approval from RPBCWD

- b) Documentation that disturbed pervious areas remaining pervious have been decompacted per Rule C Subsection 3.2c criteria
- 4. To close out this permit, the permit applicant must provide a completed chloride management plan that designates the individual authorized to implement the chloride management plan and the MPCA-certified salt applicator engaged in implementing the plan at the site.
- 5. Per Rule J, Subsection 3.1.b.ii measured infiltration capacity of the soils at the bottom of the underground infiltration system must be provided. The applicant must submit documentation verifying the infiltration capacity of the soils and that the volume control capacity is calculated using the measured infiltration rate. In addition, subsurface soil investigation is needed to verify adequate separation to groundwater (Rule J subsection 3.1.b.2). If infiltration capacity is less than needed to conform with the volume abstraction requirement in subsection 3.1b or there is inadequate separation to groundwater, design modifications to achieve compliance with RPBCWD requirements will need to be submitted (in the form of an application for a permit modification or new permit).
- 6. To close out this permit, the permit applicant must install buffer monumentation along the public waters watercourse between Lake Lucy and Lake Ann and provide a revised or amended maintenance agreement exhibit illustrating the buffer monument locations.

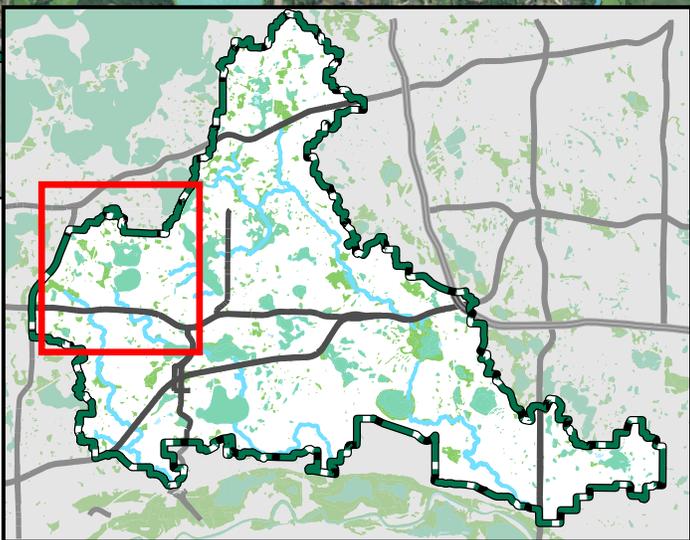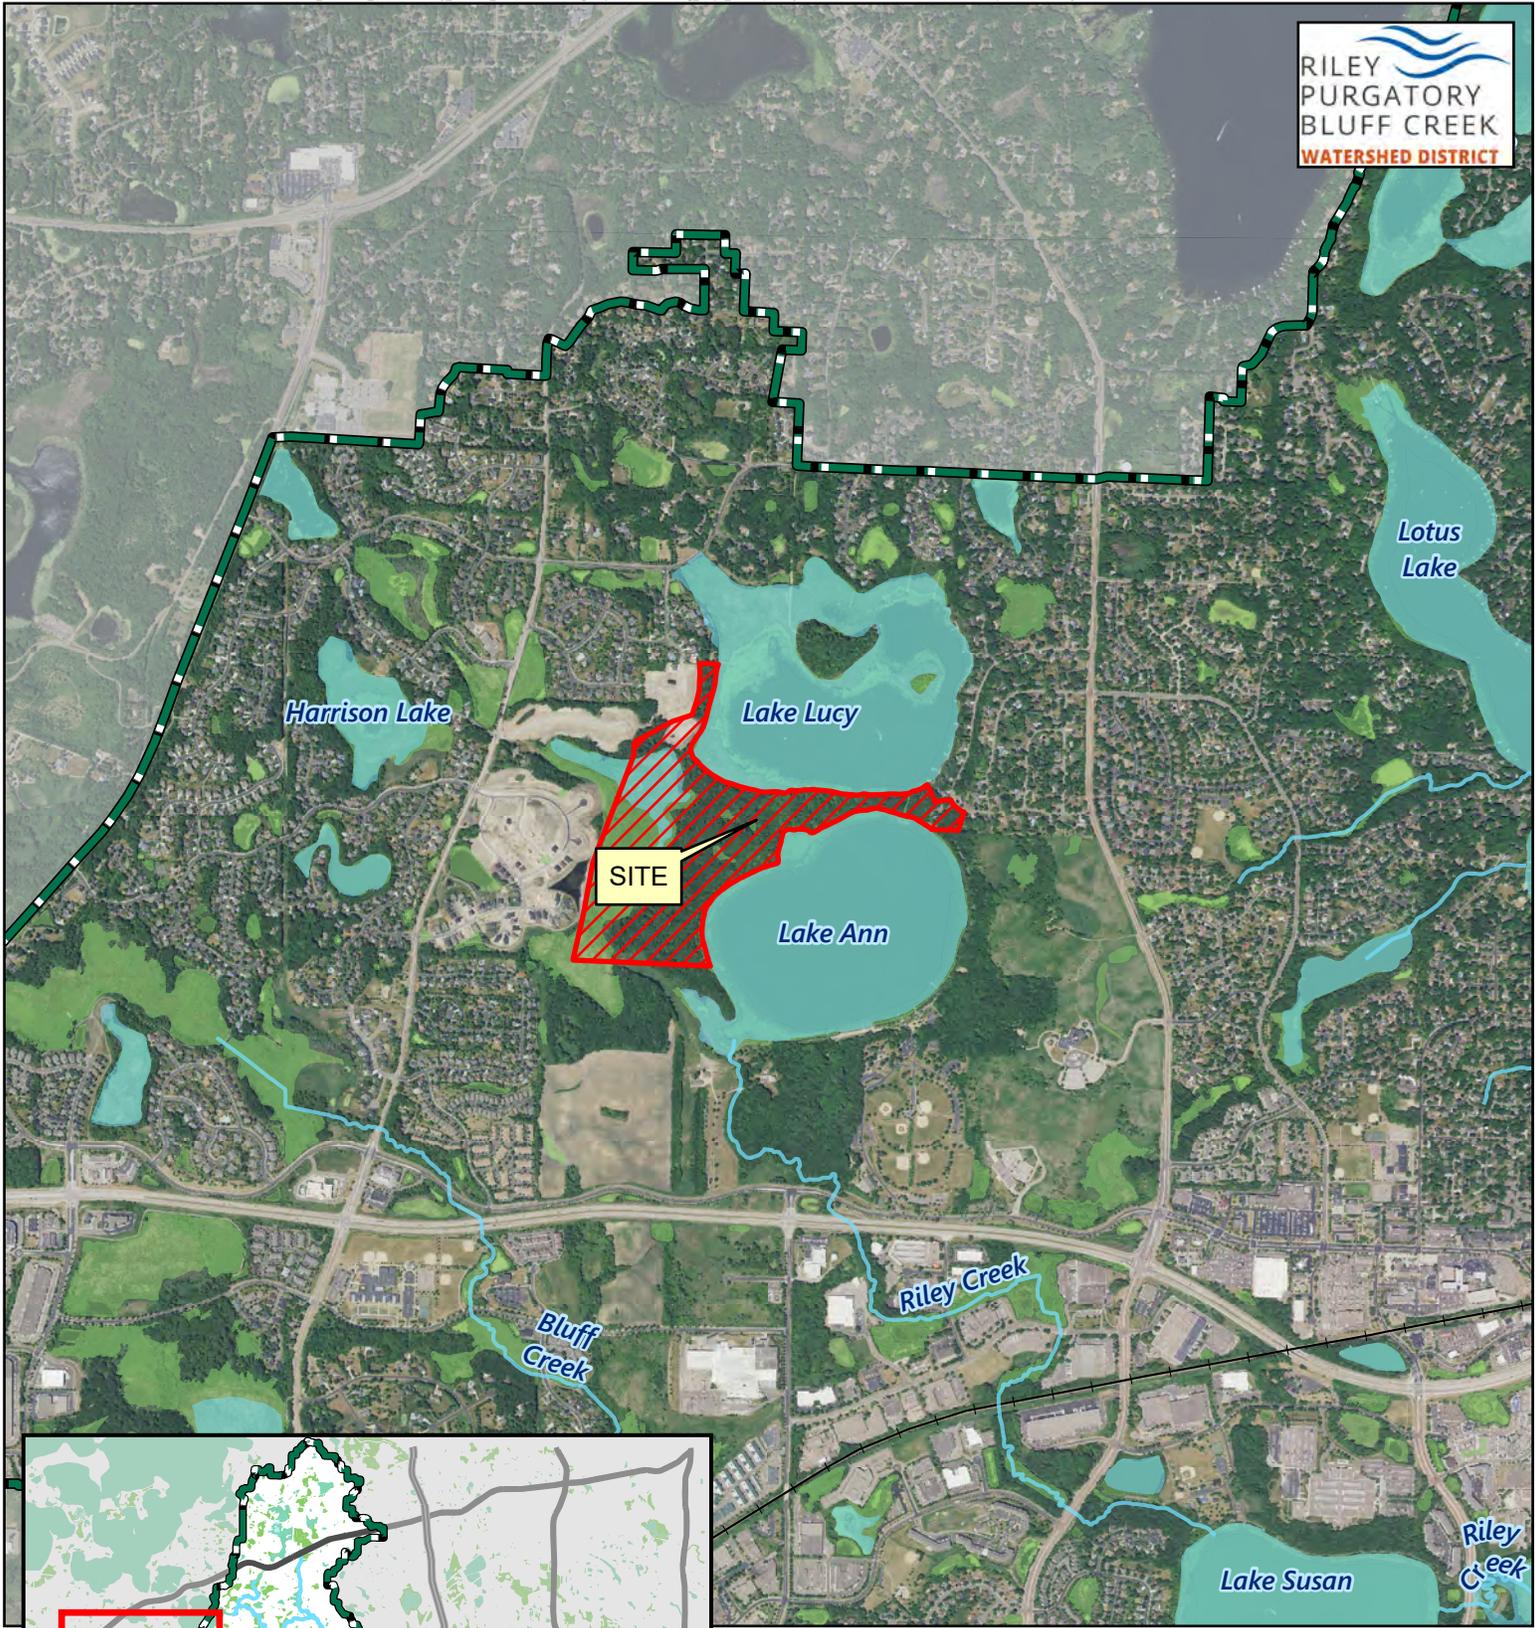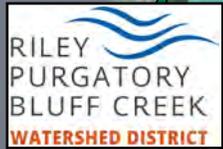

Feet



Permit Location Map

LAKE ANN PARK PRESERVE
IMPROVEMENT
Permit 2024-005
Riley Purgatory Bluff Creek
Watershed District

CITY OF CHANHASSEN, MINNESOTA

CONSTRUCTION PLANS FOR LAKE ANN PRESERVE BITUMINOUS TRAIL IMPROVEMENTS

CITY PROJECT NO. P-LAPPP2



NOTE: THIS SUBSURFACE UTILITY QUALITY INFORMATION IN THIS PLAN IS LEVEL D. THIS UTILITY QUALITY LEVEL WAS DETERMINED ACCORDING TO THE GUIDELINES OF CHASSE 38-52 ENTITLED "STANDARD GUIDELINES FOR THE COLLECTION AND DEPICTION OF EXISTING SUBSURFACE UTILITY DATA." THE CONTRACTOR SHALL CALL THE GOPHER STATE ONE CALL SYSTEM AT 811 BEFORE COMMENCING EXCAVATION.




GOVERNING SPECIFICATIONS
 THE 2020 EDITION OF THE MINNESOTA DEPARTMENT OF TRANSPORTATION "STANDARD SPECIFICATIONS FOR CONSTRUCTION," SUPPLEMENTAL SPECIFICATIONS FOR CONSTRUCTION, AND SUPPLEMENTAL SPECIFICATIONS SHALL GOVERN EXCEPT AS MODIFIED BY THE SPECIFICATIONS FOR THIS PROJECT.

ALL TRAFFIC CONTROL DEVICES SHALL CONFORM TO THE LATEST EDITION OF THE MINNESOTA MANUAL ON TRAFFIC CONTROL DEVICES, INCLUDING THE LATEST EDITION OF THE MINNESOTA TRAFFIC CONTROL DEVICES HANDBOOK.

SHEET NO.	DESCRIPTION
1	TITLE SHEET
2	CONTRACT
3	CONSTRUCTION ACCESS PLAN
4	TYPICAL SECTIONS
5-9	REMOVAL PLANS
10-14	EROSION CONTROL AND TURF ESTABLISHMENT
15-17	SWPPP
18-26	PLAN AND PROFILES
27	PARKING LOT SITE PLAN
28	PROPOSED GRADING PLAN
29	STRUCTURE SCHEDULE
30	BMP DETAILS
31	WETLAND BUFFER SIGNING
32-56	CROSS SECTIONS

THIS PLAN CONTAINS 55 SHEETS.
 IT IS INTENDED THESE PLANS BE PRINTED IN COLOR.

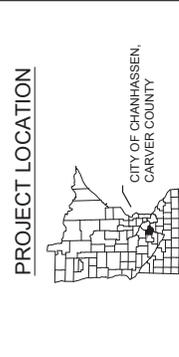

90% PRELIMINARY

CHANHASSEN, MINNESOTA


PHONE: 652.862.2800
 10000 CHURCH DRIVE, SUITE 500
 CHANHASSEN, MN 55343

SEH ENGINEERING

PROJECT NO. 171844
 SHEET NO. 1 of 55
 DATE: 01-17-2024
 Lic. No. 44581


DESIGNED BY: Jennifer C. Desbilde, PE
 CHECKED BY: [Signature]

EXISTING	PROPOSED
RIGHT OF WAY	STREET CENTERLINE
PERMANENT EASEMENT	RIGHT-OF-WAY
PROPERTY LINE	PERMANENT EASEMENT
HORIZONTAL CONTROL POINT	TEMPORARY EASEMENT
BENCHMARK	CONCRETE CURB LIMITS
SURVEY MARKER	SANITARY SEWER, BULKHEAD AND MANHOLE
SOIL BORING	FORCE MAIN
SANITARY SEWER AND MANHOLE	SANITARY SERVICE AND CLEANOUT
FORCE MAIN AND LIFT STATION	WATER MAIN, TEE, HYDRANT, BULKHEAD AND VALVE
SANITARY SEWER SERVICE & CLEANOUT	WATER VALVE MANHOLE, REDUCER, BEND AND CROSS
WATER MAIN, HYDRANT, VALVE AND MANHOLE	WATER SERVICE AND CURB STOP BOX
WATER SERVICE AND CURB STOP BOX	STORM SERVICE, MANHOLE AND CATCH BASIN
STORM SEWER, MANHOLE AND CATCH BASIN	CULVERT AND APRON ENDWALL
CULVERT AND APRON ENDWALL	DRAIN TILE
VALVE, VENT AND METER	DITCH / SWALE
MANHOLE	RIPRAP
BURIED FIBER OPTIC CABLE AND MANHOLE	STREET NAME SIGN
BURIED PHONE CABLE, PEDESTAL AND MANHOLE	SIGN (NON STREET NAME)
BURIED TV/CABLE, PEDESTAL AND MANHOLE	RETAINING WALL
BURIED ELECTRIC CABLE, PEDESTAL, MANHOLE, TRANSFORMER AND METER	
OVERHEAD WIRE, POLE AND GUY WIRE	
LIGHT POLE	
TRAFFIC SIGNAL	
STREET NAME SIGN	
SIGN (NON STREET NAME)	
RAILROAD TRACKS	
DECIDUOUS AND CONIFEROUS TREE	
BUSH / SHRUB AND STUMP	
EDGE OF WOODED AREA	
WETLAND	
BUILDING	
FENCE (UNIDENTIFIED)	
BARBED WIRE FENCE	
CHAIN LINK FENCE	
ELECTRIC WIRE FENCE	
WOOD FENCE	
WOVEN WIRE FENCE	
PLATE BEAM GUARDRAIL	
CABLE GUARDRAIL	
POST / BOLLARD	
RETAINING WALL	

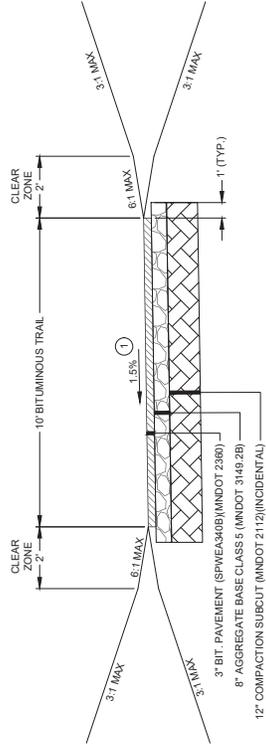


BITUMINOUS TRAIL TYPICAL SECTION A

ALL BITUMINOUS TRAIL LOCATIONS UNLESS OTHERWISE NOTED

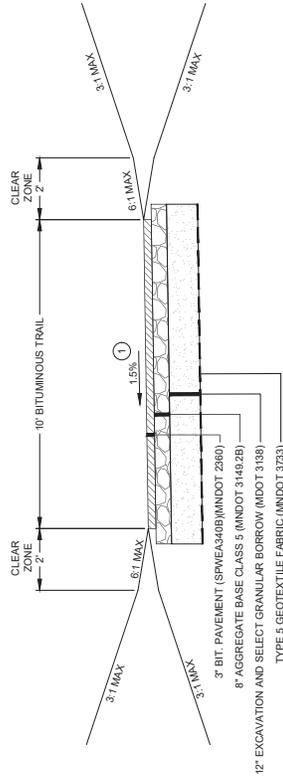


BITUMINOUS TRAIL TYPICAL SECTION B

SUBGRADE CORRECTION SECTION.
STA. 123+00 TO STA. 125+50
(OR AT DISCRETION OF THE ENGINEER)

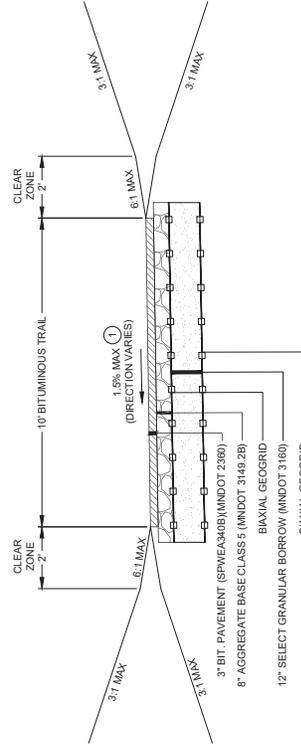

BITUMINOUS TRAIL TYPICAL SECTION C

STA. 212+00 TO STA. 213+87.75
(OR AT DISCRETION OF THE ENGINEER)

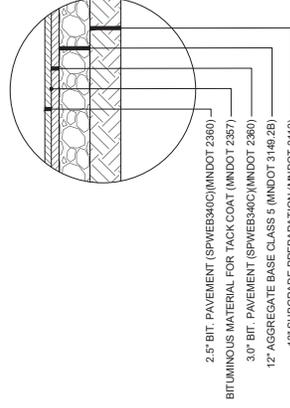

PARKING LOT PAVEMENT SECTION

NOTES:

- ① CROSS SLOPE TO BE DIRECTED TO THE DOWN GRADIENT SIDE SLOPE OF THE SURROUNDING TOPOGRAPHY.



Revision Issue Description
 90% PRELIMINARY


Rev # Date
 - -
 - -
 - -

SEH Project: H05177684
 Drawn By: -
 Designed By: -
 Checked By: -

DATE: 01-12-2024
 LICENSE NO.: 44581

LAKE ANN PRESERVE IMPROVEMENTS
 CHANHASSEN, MN

TYPICAL SECTIONS

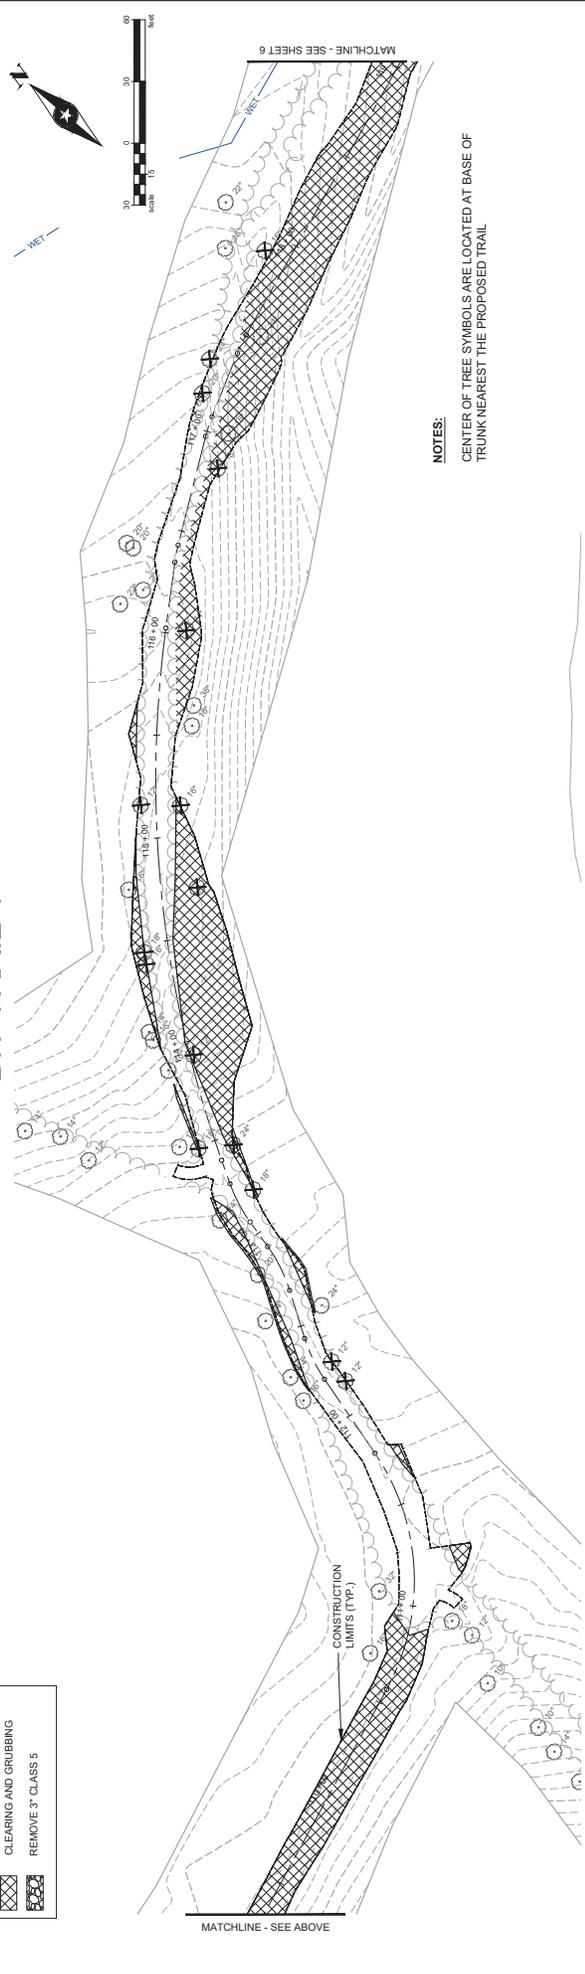

NOTES:
 CENTER OF TREE SYMBOLS ARE LOCATED AT BASE OF TRUNK NEAREST THE PROPOSED TRAIL

LEGEND:

	REMOVE HIGH VALUE TREE
	PROTECT TREE
	CLEARING AND GRUBBING
	REMOVE 3" CLASS 5

SEH Project	H0517684	Revision Issue	Disc 00000	Row #	5	LAKE ANN PRESERVE IMPROVEMENTS	REMOVAL PLANS	5
Drawn By	-	Date	-			CHANHASSEN, MN		of 55
Designed By	-							
Checked By	-							

90% PRELIMINARY

SEH

DATE: 01.12.2024
 LICENSE NO: 44581


HEREBY CERTIFY THAT THIS PLAN WAS PREPARED BY ME OR UNDER MY DIRECT SUPERVISION AND I AM A LICENSED PROFESSIONAL ENGINEER UNDER THE BOARD OF ENGINEERS AND SURVEYORS OF THE STATE OF MINNESOTA.

JENNIFER C. WILSON, P.E.
 DATE: 01.12.2024
 LICENSE NO: 44581



LEGEND:

X	REMOVE HIGH VALUE TREE
○	PROTECT TREE
▨	CLEARING AND GRUBBING

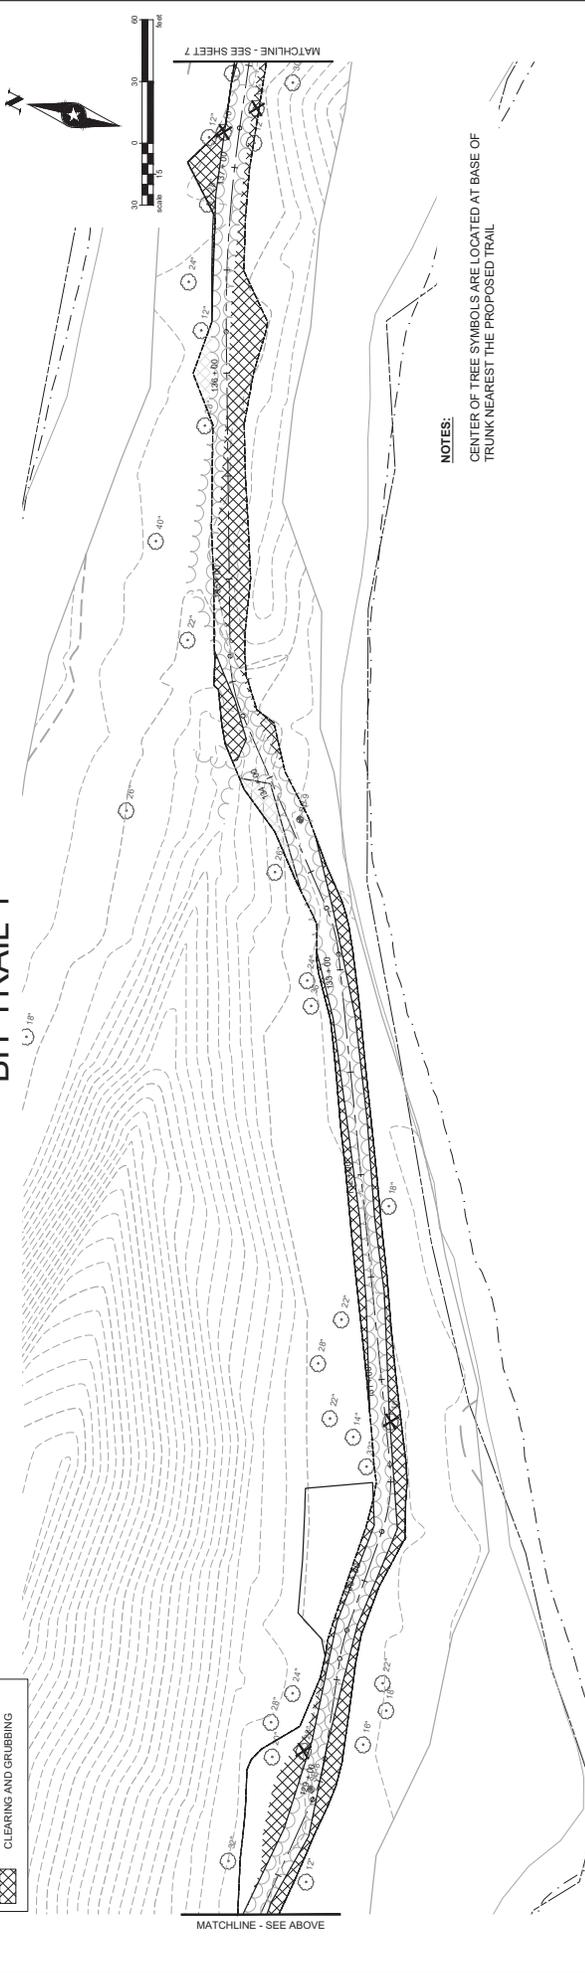

NOTES:
 CENTER OF TREE SYMBOLS ARE LOCATED AT BASE OF TRUNK NEAREST THE PROPOSED TRAIL

SEH Project	H0517684	Row #	1	Revision Issue	90% PRELIMINARY	Row #	1	Date	01-17-2024
Drawn By				Description					
Designed By									
Checked By									

SEH
 SEH ENGINEERING, INC.
 10000 Highway 101, Suite 100, Champlin, MN 55311
 PH: 763.479.2200
 FAX: 763.479.2201
 WWW.SEHENGINEERING.COM

REVISIONS:


Rev #	Date	Description
1	01-17-2024	90% PRELIMINARY

DATE: 01-17-2024
 LICENSE NO: 44581

LAKE ANN PRESERVE IMPROVEMENTS
 CHANHASSEN, MN

REMOVALS PLANS


6 of 55

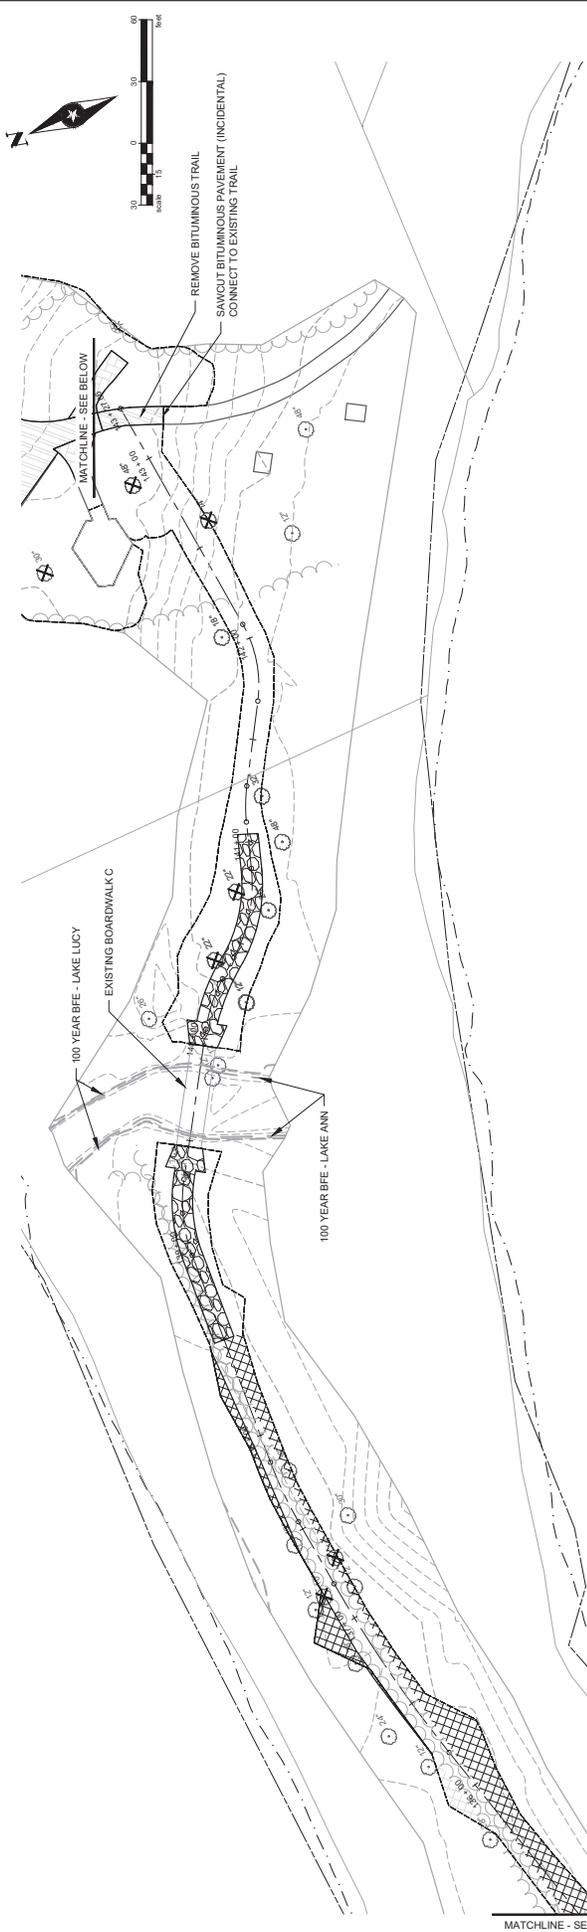

BIT TRAIL 1

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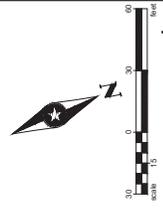
	REMOVE HIGH VALUE TREE
	PROTECT TREE
	CLEARING AND GRUBBING
	REMOVE 3" CLASS 5 PAVEMENT
	REMOVE BITUMINOUS PAVEMENT

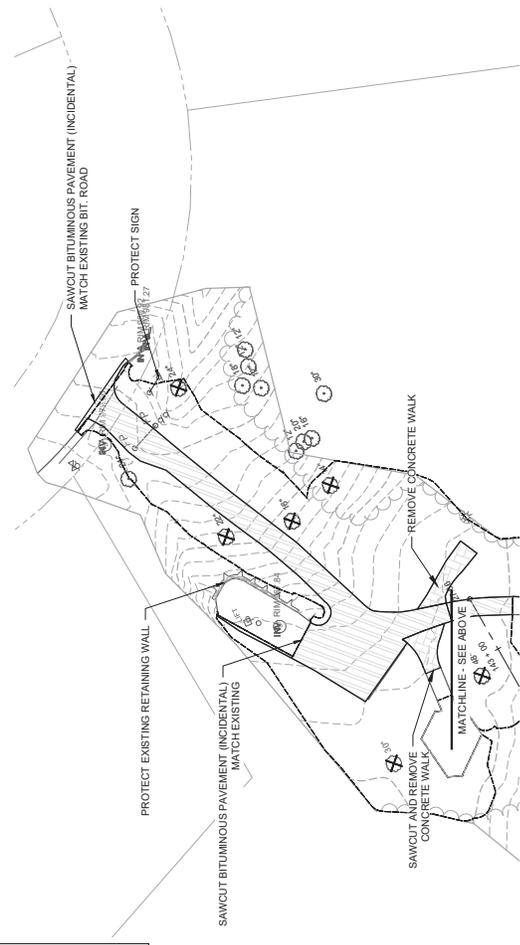

NOTES:
 CENTER OF TREE SYMBOLS ARE LOCATED AT BASE OF TRUNK NEAREST THE PROPOSED TRAIL

GREENWOOD SHORES PARKING LOT


SEH Project: H0517/684	Revision Issue: 90% PRELIMINARY	LAKE ANN PRESERVE IMPROVEMENTS	REMOVAL PLANS	7 of 55
Drawn By: [Blank]	Date: [Blank]	CHANHASSEN, MN		
Designed By: [Blank]	Revision Description: [Blank]			
Checked By: [Blank]	SEH Logo			
	DATE: 01-12-2024			




LEGEND:

X	REMOVE HIGH VALUE TREE
○	PROTECT TREE
▨	CLEARING AND GRUBBING
▩	REMOVE 3" CLASS 5

BIT TRAIL 2

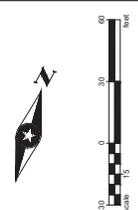

SEH Project	H03171684	Revision Issue	Discussed	Row #	1	Date	
Drawn By		Description					
Designed By							
Checked By							
90% PRELIMINARY				REMOVAL PLANS			
LAKE ANN PRESERVE IMPROVEMENTS				8			
CHANHASSEN, MN				of 55			
<small> I HEREBY CERTIFY THAT THIS PLAN WAS PREPARED BY ME OR UNDER MY DIRECT SUPERVISION AND THAT I AM A LICENSED PROFESSIONAL ENGINEER UNDER THE LAWS OF THE STATE OF MINNESOTA. JENNIFER G. ANDERSON, P.E. DATE: 01-12-2024 LICENSE NO. 44581 </small>							

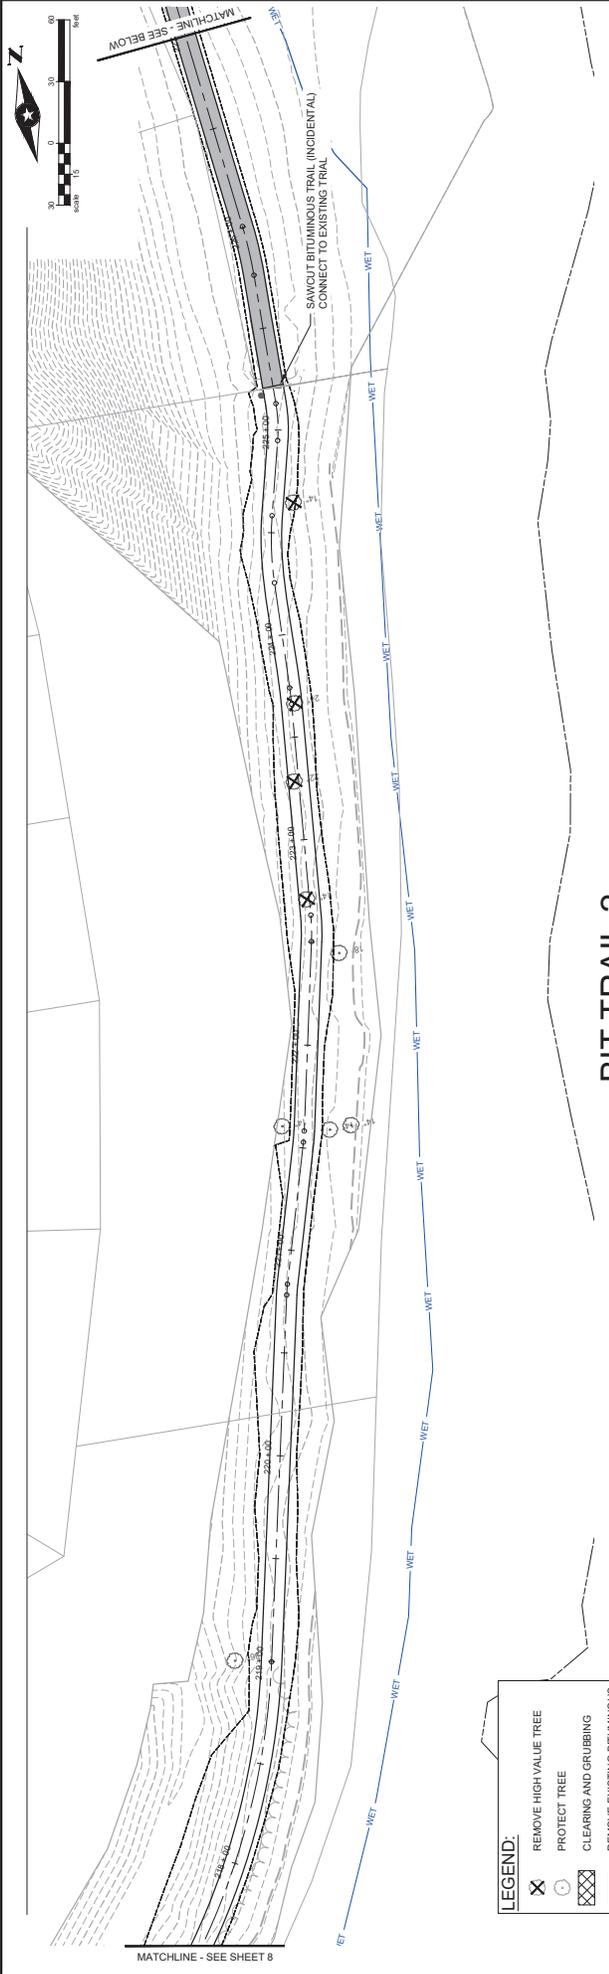

BIT TRAIL 2

LEGEND:


	REMOVE HIGH VALUE TREE
	PROTECT TREE
	CLEARING AND GRUBBING
	REMOVE EXISTING BITUMINOUS TRAIL

NOTES:
 CENTER OF TREE SYMBOLS ARE LOCATED AT BASE OF TRUNK NEAREST THE PROPOSED TRAIL



SEH Project: H05171684 Drawn By: - Designed By: - Checked By: -	Revision Issue: - Description: - Row # 1 Date: -	90% PRELIMINARY		LAKE ANN PRESERVE IMPROVEMENTS CHANHASSEN, MN	REMOVAL PLANS	9 of 55
--	---	------------------------	--	---	----------------------	-------------------

I HEREBY CERTIFY THAT THIS PLAN WAS PREPARED BY ME OR UNDER MY DIRECT SUPERVISION AND THAT I AM A LICENSED PROFESSIONAL ENGINEER UNDER THE BOARD OF PROFESSIONAL ENGINEERS AND SURVEYORS OF THE STATE OF MINNESOTA.
 JENNIFER C. GIBSON, P.E.
 DATE: 01-12-2024 LICENSE NO. 44581

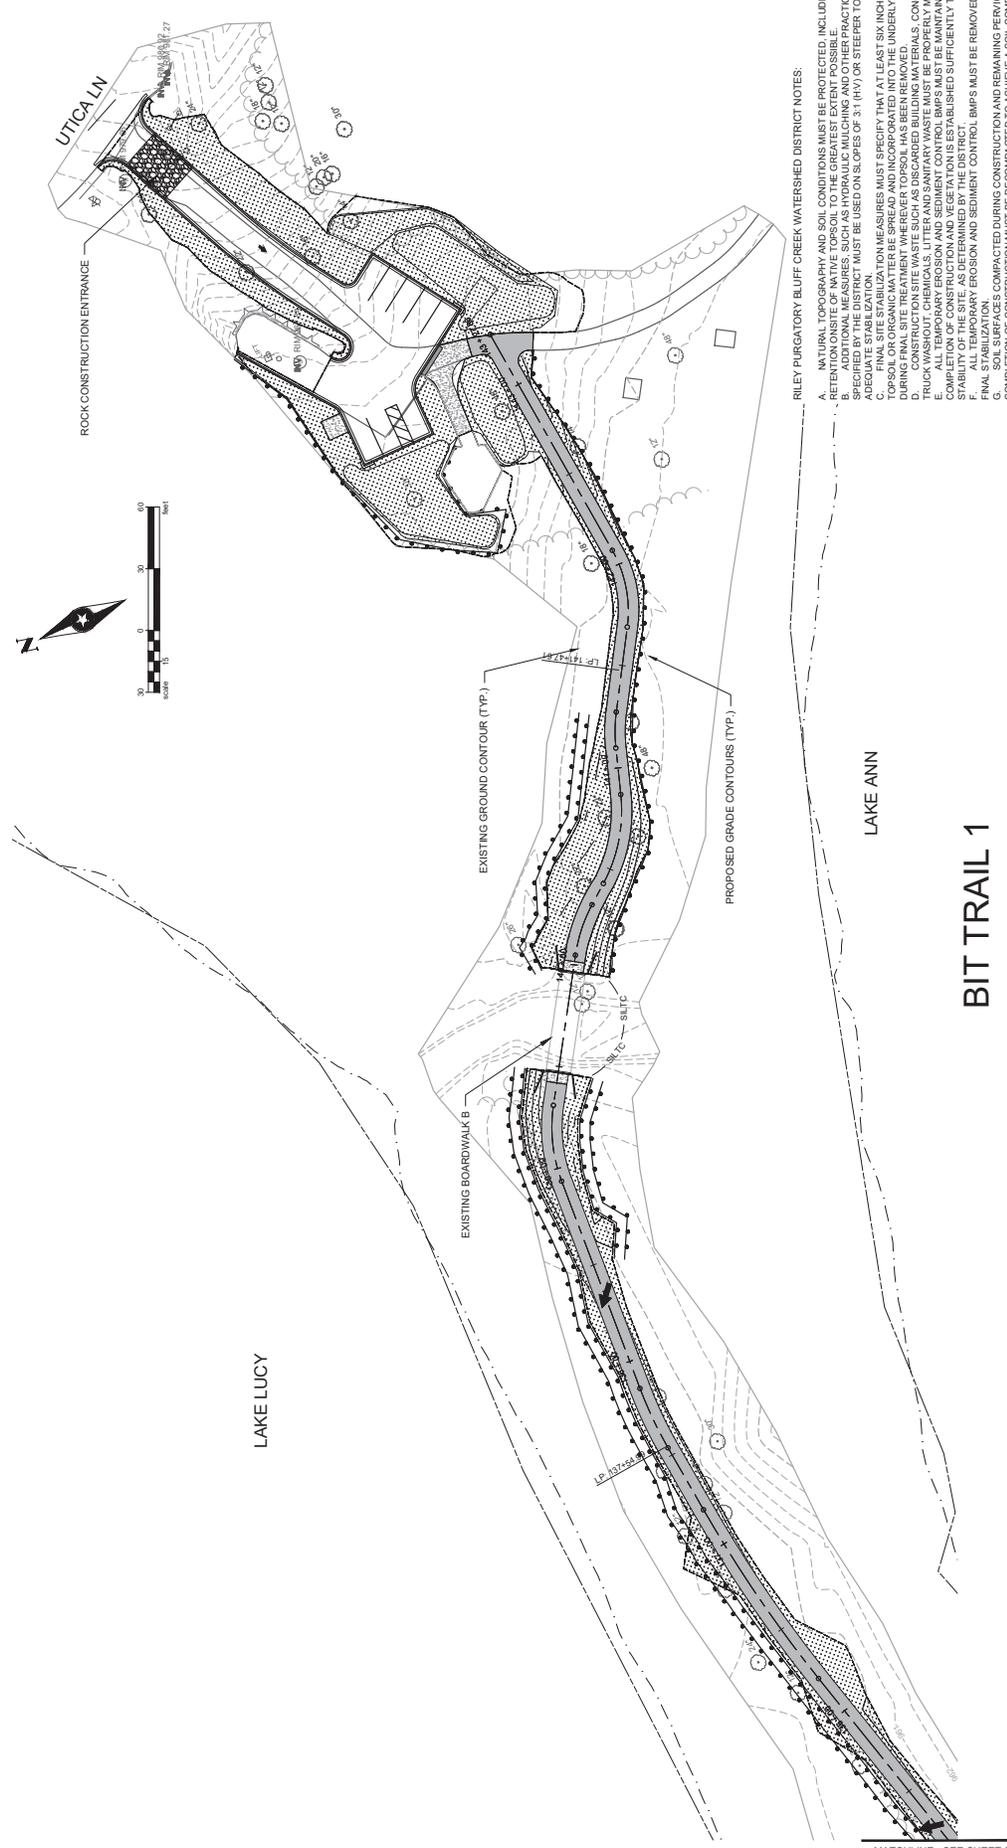

LEGEND:

- ➔ DRAINAGE DIRECTION
- BIO ROLLS
- - - CONSTRUCTION LIMITS
- ▨ 6" TOP SOIL
- ▨ MNDOT SEED MIXTURE 90-211
- ▨ HYDROSEED

- NOTES:**
- FOR ALL SLOPES GREATER THAN 3:1 AND ANY DRAINAGE CHANNELS, ANY DISTURBED AREAS ADJACENT TO RESIDENTIAL PROPERTIES THAT CONTAIN IRRIGATION SYSTEMS SHALL BE REPAIRED WITH SOD.
 - ANY IRRIGATION SYSTEMS DAMAGED BY CONSTRUCTION SHALL BE REPAIRED.

- RILEY PURGATORY BLUFF CREEK WATERSHED DISTRICT NOTES:**
- NATURAL TOPOGRAPHY AND SOIL CONDITIONS MUST BE PROTECTED, INCLUDING RETENTION ON SITE OF NATIVE TOPSOIL TO THE GREATEST EXTENT POSSIBLE.
 - EROSION CONTROL MEASURES, SUCH AS HYDRAULIC MULCHING AND OTHER PRACTICES AS APPROPRIATE, MUST BE USED ON SLOPES OF 3:1 (H/V) OR STEEPER TO PROVIDE ADEQUATE STABILIZATION.
 - FINAL SITE STABILIZATION MEASURES MUST SPECIFY THAT AT LEAST SIX INCHES OF TOP SOIL OR ORGANIC MATTER BE SPREAD AND INCORPORATED INTO THE UNDERLYING SOIL SURFACE.
 - CONSTRUCTION SITE WASTE SUCH AS DISCARDED BUILDING MATERIALS, CONCRETE TRUCK WASHOUT, CHEMICALS, LITTER AND SANITARY WASTE MUST BE PROPERLY MANAGED, STORED AND REMOVED FROM THE DISTRICT.
 - VEGETATION STABILIZATION MEASURES MUST BE ESTABLISHED SUFFICIENTLY TO ENSURE COMPLETION OF CONSTRUCTION AND VEGETATION IS ESTABLISHED SUFFICIENTLY TO ENSURE STABILITY OF THE SITE, AS DETERMINED BY THE DISTRICT.
 - ALL TEMPORARY EROSION AND SEDIMENT CONTROL BMPs MUST BE REMOVED UPON COMPLETION OF CONSTRUCTION AND REMAINING PERVIOUS UPON COMPLETION OF CONSTRUCTION MUST BE DECOMPACTED TO ACHIEVE A SOIL COMPACTION TESTING PRESSURE OF LESS THAN 1,400 KILOPASCALS OR 200 POUNDS PER SQUARE INCH. TESTING SHALL BE PERFORMED AT 1' INTERVALS FROM THE SURFACE TO 6" BELOW THE SURFACE.
 - ALL DISTURBED AREAS MUST BE STABILIZED WITHIN 7 CALENDAR DAYS AFTER DRAINAGE DRAINAGE WORK HAS COMPLETED OR SEVERELY CEASED ON A PROPERTY THAT IS NOT PERMITTED TO BE OPEN TO THE PUBLIC.
 - THE PERMITTEE MUST, AT A MINIMUM, INSPECT, MAINTAIN AND REPAIR ALL DISTURBED SURFACES AND ALL EROSION AND SEDIMENT CONTROL FACILITIES AND SOIL STABILIZATION MEASURES AT LEAST WEEKLY UNTIL VEGETATIVE COVER IS ESTABLISHED. THE PERMITTEE SHALL MAINTAIN A LOG OF ACTIVITIES UNDER THIS SECTION FOR INSPECTION BY THE DISTRICT.
 - PERMITTEE WILL MAINTAIN A LOG OF ACTIVITIES UNDER THIS SECTION FOR INSPECTION BY THE DISTRICT.
 - ACTIVITIES MUST BE CONDUCTED SO AS TO MINIMIZE THE POTENTIAL TRANSFER OF AQUATIC INVASIVE SPECIES (E.G., ZEBRA MUSSELS, EURASIAN WATERMILFOIL, ETC.) TO THE MAXIMUM EXTENT POSSIBLE.

LAKE ANN PRESERVE IMPROVEMENTS ESTABLISHMENT PLAN

CHANHASSEN, MN

12 of 55

SEH PROJECT: H05171684
 DRAWN BY: [Redacted]
 DESIGNED BY: [Redacted]
 CHECKED BY: [Redacted]

REVISION ISSUE: [Redacted]
 DESCRIPTION: [Redacted]

DATE: [Redacted]

ROW # [Redacted]

90% PRELIMINARY

SEH

LAKE ANN PRESERVE IMPROVEMENTS ESTABLISHMENT PLAN

12 of 55

I HEREBY CERTIFY THAT THIS PLAN WAS PREPARED BY ME OR UNDER MY DIRECT SUPERVISION AND THAT I AM A LICENSED PROFESSIONAL ENGINEER UNDER THE BOARD OF ENGINEERS AND SURVEYORS OF THE STATE OF MINNESOTA. DATE: 01-12-2024 LICENSE NO: 44581



BIT TRAIL 2

RILEY PURGATORY BLUFF CREEK WATERSHED DISTRICT NOTES.


- NATURAL TOPOGRAPHY AND SOIL CONDITIONS MUST BE PROTECTED, INCLUDING RETENTION OF ALL EXISTING VEGETATION. VEGETATION SHALL BE MAINTAINED AND PROTECTED TO THE MAXIMUM EXTENT POSSIBLE. ADDITIONAL MEASURES, SUCH AS MULCHING AND OTHER PRACTICES AS SPECIFIED BY THE DISTRICT MUST BE USED ON SLOPES OF 3:1 (H:V) OR STEEPER TO PROVIDE ADEQUATE STABILIZATION.
- CONSTRUCTION MEASURES MUST SPECIFY THAT AT LEAST SIX INCHES OF TOP SOIL OR ORGANIC MATTER BE SPREAD AND INCORPORATED INTO THE UNDERLYING SOIL DURING FINAL SITE TREATMENT WHEREVER TOPSOIL HAS BEEN REMOVED.
- CONSTRUCTION SITE WASTE SUCH AS DISCARDED BUILDING MATERIALS, CONCRETE, PAINT, OIL, AND OTHER HAZARDOUS WASTE SHALL BE MAINTAINED UNTIL PROPER DISPOSAL IS ARRANGED BY THE DISTRICT.
- ALL TEMPORARY EROSION AND SEDIMENT CONTROL BMPs MUST BE MAINTAINED UNTIL COMPLETION OF CONSTRUCTION AND VEGETATION IS ESTABLISHED SUFFICIENTLY TO ENSURE STABILITY OF THE SITE, AS DETERMINED BY THE DISTRICT.
- ALL TEMPORARY EROSION AND SEDIMENT CONTROL BMPs MUST BE REMOVED UPON FINAL STABILIZATION.
- SOIL SURFACES COMPACTED DURING CONSTRUCTION AND REMAINING PERSISTENT UPON COMPLETION OF CONSTRUCTION SHALL BE REPAIRED TO ORIGINAL OR BETTER CONDITION. TESTING PRESSURE OF LESS THAN 1,400 POUNDS PER SQUARE INCH SHALL BE REQUIRED FOR THE UPPER 12 INCHES OF THE SOIL PROFILE WHILE TAKING CARE TO PROTECT UTILITIES, TREE ROOTS, AND OTHER EXISTING VEGETATION.
- LAND-DISTURBING WORK HAS TEMPORARILY OR PERMANENTLY CEASED ON A PROPERTY THAT DRAINS TO AN IMPAIRED WATER, WITHIN 14 DAYS ELSEWHERE.
- THE PERMITTEE MUST, AT A MINIMUM, INSPECT, MAINTAIN AND REPAIR ALL DISTURBED AREAS EVERY DAY WORK IS PERFORMED ON THE SITE AND AT LEAST WEEKLY UNTIL LAND-DISTURBING ACTIVITY HAS CEASED. THEREAFTER, THE PERMITTEE MUST PERFORM THESE RESPONSIBILITIES AT LEAST WEEKLY UNTIL VEGETATIVE COVER IS ESTABLISHED. THE DISTRICT ON REQUEST.
- ACTIVITIES MUST BE CONDUCTED SO AS TO MINIMIZE THE POTENTIAL TRANSFER OF MATERIALS (E.G. ZEBRA MUSSELS, EUASIAN WATERMILFOIL, ETC.) TO THE MAXIMUM EXTENT POSSIBLE.

LEGEND:


- ↑ DRAINAGE DIRECTION
- BIO ROLLS
- CONSTRUCTION LIMITS
- ▨ 6" TOP SOIL
- ▨ MANDOT SEED MIXTURE 38-211
- ▨ HYDROSEED

NOTES:

- FOR ALL SLOPES GREATER THAN 4:1 AND ANY DRAINAGE CHANNELS, UTILIZE EROSION CONTROL BLANKET.
- ANY DISTURBED AREAS ADJACENT TO RESIDENTIAL PROPERTIES THAT ARE DAMAGED BY CONSTRUCTION SHALL BE REPAIRED.
- ANY IRRIGATION SYSTEMS DAMAGED BY CONSTRUCTION SHALL BE REPAIRED.

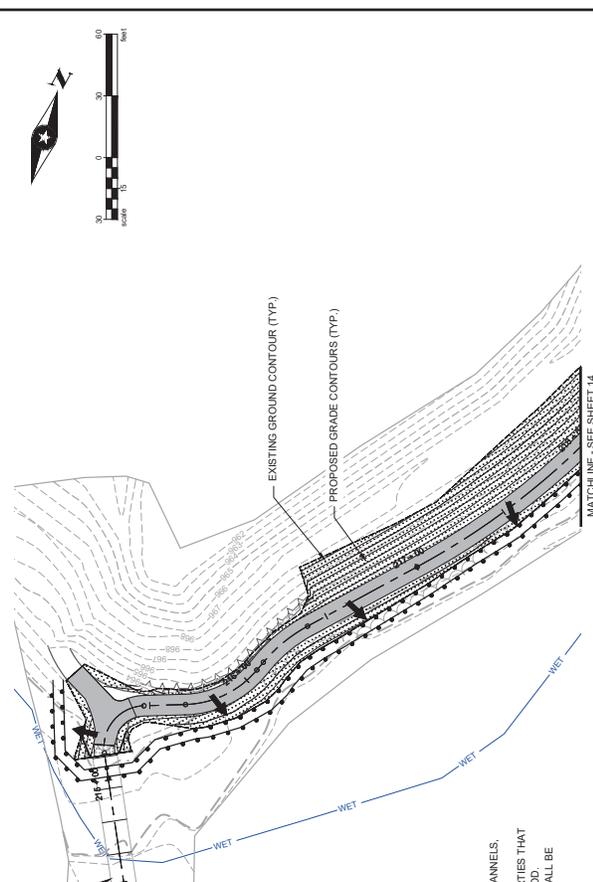

SHEET: 2/19/2024 12:14 PM Admin Plot: 2/28/2024 12:08 PM X:\P\H\CHS\171858-6-Field-dg\171858-6-Field-dg\171858-6-Field-dg\171858-6-Field-dg.dwg Scale: 1"=40' Date: 01-12-2024 License No: 44581	Revision Issue Description Row # Date	Revision Issue Description Row # Date	Revision Issue Description Row # Date
SEH Project: H0817/684 Drawn By: [Blank] Designed By: [Blank] Checked By: [Blank]	90% PRELIMINARY	SEH	I HEREBY CERTIFY THAT THIS PLAN WAS PREPARED BY ME OR UNDER MY DIRECT SUPERVISION AND THAT I AM A LICENSED PROFESSIONAL ENGINEER UNDER THE BOARD OF PROFESSIONAL ENGINEERS OF THE STATE OF MINNESOTA. JENNIFER A. GIBSON, P.E. DATE: 01-12-2024 LICENSE NO: 44581
MATCHLINE - SEE ABOVE		MATCHLINE - SEE SHEET 14	
LAKE ANN PRESERVE IMPROVEMENTS CHANHASSEN, MN		EROSION CONTROL AND TURF ESTABLISHMENT PLAN	
13 of 55		13 of 55	

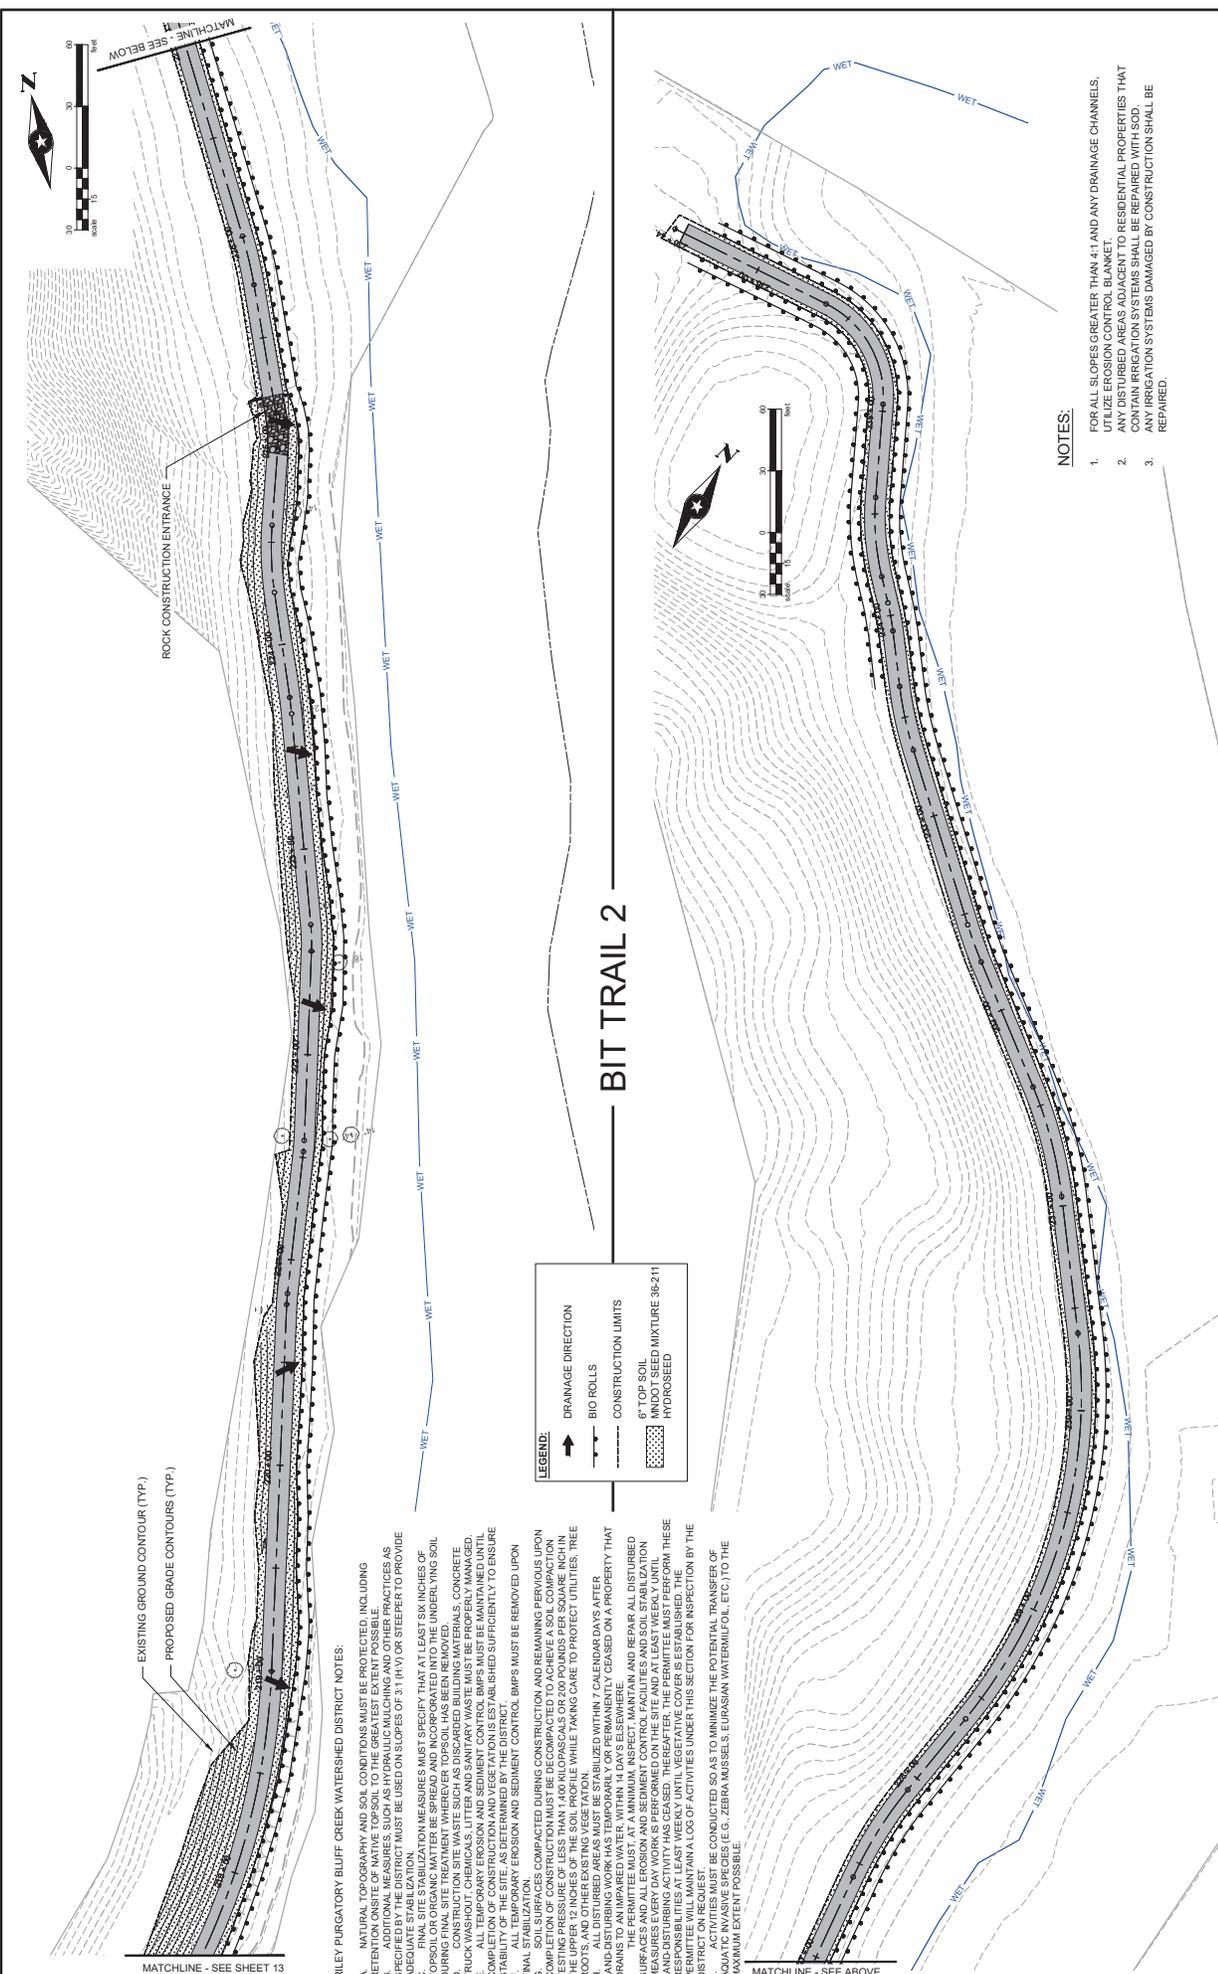

BIT TRAIL 2



EXISTING GROUND CONTOUR (TYP.)
 PROPOSED GRADE CONTOURS (TYP.)

MATCHLINE - SEE SHEET 13

RILEY PURGATORY BLUFF CREEK WATERSHED DISTRICT NOTES:

- A. NATURAL TOPOGRAPHY AND SOIL CONDITIONS MUST BE PROTECTED, INCLUDING RETENTION ORIENTE OF NATIVE TOPSOIL TO THE GREATEST EXTENT POSSIBLE.
- B. ADDITIONAL MEASURES, SUCH AS HYDRAULIC MULCHING AND OTHER PRACTICES AS SPECIFIED BY THE DISTRICT MUST BE USED ON SLOPES OF 3:1 (H:V) OR STEEPER TO PROVIDE EROSION CONTROL.
- C. FINAL SITE STABILIZATION MEASURES MUST SPECIFY THAT AT LEAST SIX INCHES OF TOPSOIL OR ORGANIC MATTER BE SPREAD AND INCORPORATED INTO THE UNDERLYING SOIL.
- D. CONSTRUCTION WASTE SUCH AS DISCARDED BUILDING MATERIALS, CONCRETE TRUCK WASHOUT, CHEMICALS, LITTER AND SANITARY WASTE MUST BE PROPERLY MANAGED.
- E. ALL TEMPORARY EROSION AND SEDIMENT CONTROL BMPs MUST BE MAINTAINED UNTIL THE DISTRICT IS SATISFIED WITH THE STABILIZATION OF THE SITE. AS DETERMINED BY THE DISTRICT.
- F. ALL TEMPORARY EROSION AND SEDIMENT CONTROL BMPs MUST BE REMOVED UPON FINAL STABILIZATION.
- G. COMPACTED DURING CONSTRUCTION AND REMAINING PERSISTENT UPON COMPLETION OF CONSTRUCTION MUST BE DECOMPACTED TO ACHIEVE A SOIL COMPACTION TESTING PRESSURE OF LESS THAN 1,400 KILOPASCALS OR 200 POUNDS PER SQUARE INCH IN DEPTHS UP TO 12 INCHES FROM THE SURFACE.
- H. ALL DISTURBED AREAS MUST BE STABILIZED WITHIN 7 CALENDAR DAYS AFTER COMPLETION OF CONSTRUCTION.
- I. THE PERMITTEE MUST AT A MINIMUM, INSPECT, MAINTAIN AND REPAIR ALL DISTURBED SURFACES AND ALL EROSION AND SEDIMENT CONTROL FACILITIES AND SOIL STABILIZATION MEASURES EVERY DAY WORK IS PERFORMED ON THE SITE AND AT LEAST WEEKLY UNTIL PERMITTEE WILL MAINTAIN A LOG OF ACTIVITIES UNDER THIS SECTION FOR INSPECTION BY THE DISTRICT ON REQUEST.
- J. AQUATIC INVASIVE SPECIES (E.G. ZEBRA MUSSELS, EURASIAN WATERMILFOL, ETC.) TO THE MAXIMUM EXTENT POSSIBLE.

LEGEND:

- ➔ DRAINAGE DIRECTION
- BIO ROLLS
- CONSTRUCTION LIMITS
- ▨ 6" TOP SOIL
- ▨ MNDOT SEED MIXTURE 36-211 HYDROSEED

NOTES:

1. FOR ALL SLOPES GREATER THAN 4:1 AND ANY DRAINAGE CHANNELS, UTILIZE EROSION CONTROL BLANKET.
2. ANY DISTURBED AREAS ADJACENT TO RESIDENTIAL PROPERTIES THAT CONTAIN IRRIGATION SYSTEMS SHALL BE REPAIRED WITH SOD.
3. ANY IRRIGATION SYSTEMS DAMAGED BY CONSTRUCTION SHALL BE REPAIRED.

SHEET PROJECT: H058176804 DRAWN BY: [Redacted] DESIGNED BY: [Redacted] CHECKED BY: [Redacted]	REVISION ISSUE # [Redacted] REVISION DESCRIPTION [Redacted]	ROW # [Redacted] DATE [Redacted]	90% PRELIMINARY 	LAKE ANN PRESERVE IMPROVEMENTS EROSION CONTROL AND TURF ESTABLISHMENT PLAN CHANHASSEN, MN	14 OF 55
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I HEREBY CERTIFY THAT THIS PLAN WAS PREPARED BY ME OR UNDER MY DIRECT SUPERVISION AND THAT I AM A LICENSED PROFESSIONAL ENGINEER UNDER THE PROVISIONS OF THE ENGINEERING BOARD OF MINNESOTA.
 JENNIFER C. JOHNSON, P.E.
 DATE: 01-12-2024
 LICENSE NO. 44581

SWPPP SUMMARY/OVERVIEW: PRESENTATION (AN SWPPP) HAS BEEN DEVELOPED TO ADDRESS THE REQUIREMENTS OF NPDES PERMIT MNR100001. THIS SWPPP INCLUDES A COMBINATION OF NARRATIVE AND PLAN SHEETS THAT DESCRIBE THE TEMPORARY AND PERMANENT STORM WATER MANAGEMENT PLAN FOR THE PROJECT.

PROJECT INFORMATION:

LOCATION:	LAKE ANN PRESERVE, CHANHASSEN, MINNESOTA
LATITUDE/LONGITUDE:	44.8749° N / 93.9514° W
PROJECT DESCRIPTION:	TRAIL AND PARKING LOT IMPROVEMENTS
SOIL DISTURBING ACTIVITIES:	REMOVALS, GRADING

CONTACTS:

OWNER:	CITY OF CHANHASSEN
CONTACT:	JERRY RUEGEMER, PARKS & RECREATION DIRECTOR
ADDRESS:	7700 MARKET BLVD, PO BOX 147, CHANHASSEN, MN 55317
PHONE:	952.227.1121
EMAIL:	JRUEGEMER@CHANHASSEN.MN.GOV
ENGINEER:	SHORT ELLIOTT HENDRICKSON INC. (SEH)
CONTACT:	JEN DESRUDE
PHONE:	952.912.2810
EMAIL:	jdesru@sehinc.com
PROJECT NO.:	CHAPR 176519

KNOWLEDGEABLE PERSON/CHAIN OF RESPONSIBILITY: THE CONTRACTOR SHALL IDENTIFY A PERSON KNOWLEDGEABLE AND EXPERIENCED IN THE APPLICATION OF EROSION PREVENTION AND SEDIMENT CONTROL BMPs WHO WILL COORDINATE WITH ALL CONTRACTORS, SUBCONTRACTORS, AND OPERATORS ON-SITE TO SUPERVISE THE IMPLEMENTATION OF THE SWPPP.

CONTRACTOR:	CITY OF CHANHASSEN PUBLIC WORKS
CONTACT:	JOE SEIDL
PHONE:	952.227.1168
EMAIL:	SEIDL@CHANHASSEN.MN.GOV

THE CONTRACTOR SHALL ESTABLISH A CHAIN OF RESPONSIBILITY FOR ALL CONTRACTORS AND SUB-CONTRACTORS TO PROVIDE THE CHAIN OF RESPONSIBILITY TO THE OWNER AND ATTACH TO THE SWPPP PRIOR TO ANY CONSTRUCTION ACTIVITY.

GENERAL SWPPP RESPONSIBILITIES: THE CONTRACTOR SHALL KEEP THE SWPPP ON-SITE, OR ELECTRONICALLY AVAILABLE ON-SITE, DURING NORMAL WORKING HOURS WITH PERSONNEL WHO HAVE OPERATIONAL CONTROL OVER THE APPLICABLE PORTION OF THE SITE, INCLUDING ALL CHANGES TO THE SWPPP, INSPECTIONS, AND MAINTENANCE RECORDS.

THE SWPPP WILL BE AMENDED AS NEEDED AND/OR AS REQUIRED BY PROVISIONS OF THE PERMIT. PERMITTEES MUST AMEND THE SWPPP TO INCLUDE ADDITIONAL OR MODIFIED BMPs AS NECESSARY TO CORRECT PROBLEMS IDENTIFIED BY WEATHER OR SEASONAL CONDITIONS HAVING A SIGNIFICANT EFFECT ON THE DISCHARGE OF POLLUTANTS TO SURFACE WATERS OR GROUNDWATER. AMENDMENTS WILL BE APPROVED BY BOTH THE OWNER AND CONTRACTOR AND WILL BE ATTACHED OR OTHERWISE INCLUDED WITH THE SWPPP DOCUMENTS. THE SWPPP AMENDMENTS SHALL BE INITIATED, FACILITATED, AND PROCESSED BY THE CONTRACTOR.

PERMITTEES MUST AMEND THE SWPPP WITHIN 7 DAYS TO INCLUDE ADDITIONAL OR MODIFIED BMPs WHENEVER THERE IS A CHANGE IN DESIGN, CONSTRUCTION, OPERATION, MAINTENANCE, WEATHER OR SEASONAL CONDITIONS HAVING A SIGNIFICANT EFFECT ON THE DISCHARGE OF POLLUTANTS TO SURFACE WATERS OR GROUNDWATER.

PERMITTEES MUST AMEND THE SWPPP WITHIN 7 DAYS TO INCLUDE ADDITIONAL OR MODIFIED BMPs AS NECESSARY TO CORRECT PROBLEMS IDENTIFIED BY WEATHER OR SEASONAL CONDITIONS HAVING A SIGNIFICANT EFFECT ON THE DISCHARGE OF POLLUTANTS TO SURFACE WATERS OR GROUNDWATER. AMENDMENTS WILL BE APPROVED BY BOTH THE OWNER AND CONTRACTOR AND WILL BE ATTACHED OR OTHERWISE INCLUDED WITH THE SWPPP DOCUMENTS. THE SWPPP AMENDMENTS SHALL BE INITIATED, FACILITATED, AND PROCESSED BY THE CONTRACTOR.

ALL SWPPP CHANGES MUST BE DONE BY AN INDIVIDUAL TRAINED IN ACCORDANCE WITH SECTION 21.2, CHANGES INVOLVING THE USE OF A LESS STRINGENT BMP MUST INCLUDE A JUSTIFICATION DESCRIBING HOW THE REPLACEMENT BMP IS EFFECTIVE FOR THE SITE CHARACTERISTICS.

BOTH THE OWNER AND CONTRACTOR SHALL BE RESPONSIBLE FOR THE PROPER TERMINATION AND/OR TRANSFER OF LONG TERM OPERATION AND MAINTENANCE.

THE OWNER WILL BE RESPONSIBLE FOR THE LONG TERM OPERATION AND MAINTENANCE OF THE PERMANENT STORMWATER MANAGEMENT SYSTEM(S).

THE OWNER WILL PREPARE AND IMPLEMENT A PERMANENT STORMWATER TREATMENT SYSTEM(S) MAINTENANCE PLAN.

TRAINING DOCUMENTATION:

PREPARED/DESIGNER OF SWPPP:	BLAKE K. HANSEN
EMPLOYER:	SEH INC.
DATE OBTAINED / REFRESHED:	MAY 2023
INSTRUCTOR(S)/EVENT PROVIDING TRAINING:	UNIVERSITY OF MINNESOTA

CONTENT OF TRAINING AVAILABLE UPON REQUEST.

THE CONTRACTOR (OPERATOR) SHALL ADD TO THE SWPPP TRAINING RECORDS FOR THE FOLLOWING PERSONNEL: INDIVIDUALS OVERSEENING THE IMPLEMENTATION OF, REVISIONS, AND AMENDING THE SWPPP INDIVIDUALS PERFORMING INSPECTIONS INDIVIDUALS PERFORMING OR SUPERVISING THE INSTALLATION, MAINTENANCE AND REPAIR OF BMPs TRAINING MUST RELATE TO THE INDIVIDUAL'S JOB DUTIES AND RESPONSIBILITIES AND SHALL INCLUDE:

- DATES OF TRAINING
 - NAME OF INSTRUCTORS
 - CONTENT AND EVENT PROVIDING TRAINING
- THE CONTRACTOR SHALL ENSURE THAT THE INDIVIDUALS ARE TRAINED BY LOCAL, STATE, FEDERAL AGENCIES, PROFESSIONAL ORGANIZATIONS, OR OTHER ENTITIES WHO WILL EXPERIENCE IN EROSION PREVENTION, SEDIMENT CONTROL, PERMANENT STORMWATER MANAGEMENT AND THE MINNESOTA NPDES CONSTRUCTION STORMWATER PERMIT.

PROJECT SUMMARY:

TOTAL DISTURBED AREA:	3.749 AC
PRE-CONSTRUCTION IMPERVIOUS AREA:	0.141 AC
POST-CONSTRUCTION IMPERVIOUS AREA:	0.213 AC
IMPERVIOUS AREA ADDED:	0.072 AC

IN ACCORDANCE WITH THE NPDES AND NPDES PERMITS REGULATORY TRAILS SET APART FROM ROADWAYS ARE NOT CONSIDERED IMPERVIOUS UNDER MPCA NPDES CSW PERMIT CONDITIONS TRAILS AT OR LESS THAN TEN (10) FEET IN WIDTH AND BORDERED DOWNGRADIENT BY SUFFICIENT PERVIOUS AREA ARE NOT CONSIDERED REGULATED IMPERVIOUS BY THE BORROW. THE PROJECT INCLUDES THE CONSTRUCTION OF 1.51 MILES OF BUTAUMINOUS TRAIL AREAS WHEN EXCLUDING TRAILS.

RECEIVING WATER(S) WITHIN ONE MILE FROM PROJECT BOUNDARIES:

ID	NAME	TYPE	SPECIAL WATER?	IMPAIRED WATER?	RELATED IMPAIRMENT OR CLASSIFICATION	TMDL
10-0007-00	LUCY LAKE	LAKE	N	Y	NONE	MERCURY
10-0012-00	ANN LAKE	LAKE	N	Y	NONE	MERCURY
07-020112-857	RILEY STREAM	STREAM	N	N	N/A	N/A

ADDITIONAL BMPs AND/OR ACTIONS REQUIRED: NONE.

SEE SECTION 23 OF THE PERMIT AND APPLICABLE TMDL WLAS

WATERBODY	NO WORK DURING
LAKES	APRIL 1 - JUNE 30
NON-TROUT STREAMS	MARCH 15 - JUNE 15
TROUT STREAMS	SEPTEMBER 1 - APRIL 1

SITE SOIL INFORMATION: (SOIL INFORMATION PROVIDED FOR NPDES PERMIT INFORMATION ONLY. SOIL INFORMATION WAS OBTAINED FROM THE PROJECT SITE. THE CONTRACTOR SHALL NOT RELY ON THIS SOIL INFORMATION FOR CONSTRUCTION PURPOSES).

SOIL NAME	HYDROLOGIC CLASSIFICATION:
CANISTEO CLAY LOAM	C/D
ESSEXVILLE SANDY LOAM	B/D
KILKENNY-LESTER LOAMS	C/D
LESTER-KILKENNY LOAMS	B
LESTER-KILKENNY COMPLEX	C
MUSKOGEE AND HOUGHTON SOILS	C/D
KLOSSNER AND MUSKOGEE SOILS	C/D
TEHRILL LOAM	B

RELATED REVIEWS & PERMITS: ENVIRONMENTAL WETLAND, LOCAL, STATE, AND/OR OTHER DETERMINATIONS, OR THE MITIGATIVE SEQUENCE REQUIRED IN SECTION 22 OF THE NPDES PERMIT MNR100001 HAVE BEEN FINALIZED AND DOCUMENTED.

AGENCY:	TYPE OF PERMIT:
RILEY PURGATORY BLUFF CREEK WATERSHED DISTRICT	WATERSHED
MNDNR	PUBLIC WATERS WORK PERMIT
NPDES	CONSTRUCTION STORMWATER PERMIT

IMPLEMENTATION SEQUENCE: COMPLETELY WITH THE FOLLOWING SEQUENCE. THE ENGINEER MAY APPROVE ADJUSTMENTS TO THE SEQUENCE AS NEEDED.

- INSTALL ROCK CONSTRUCTION ENTRANCES(S)
- INSTALL PERIMETER CONTROL AND STABILIZE DOWN GRADIENT BOUNDARIES
- INSTALL INLET PROTECTION ON EXISTING CATCH BASINS
- COMPLETE SITE GRADING
- INSTALL UTILITIES, STORM SEWER, INLET PROTECTION, CURB & GUTTER, PAVING
- COMPLETE FINAL GRADING AND STABILIZE DISTURBED AREAS
- IF ANY CONSTRUCTION COMPLETE AND THE SITE IS STABILIZED, REMOVE ALL TEMPORARY EROSION CONTROL BMPs, AND RE-STABILIZE ANY AREAS DISTURBED BY THEIR REMOVAL
- INSTALL FILTRATION MEDIA

PROJECT SPECIFIC NOTES:

- NATURAL TOPOGRAPHY AND SOIL CONDITIONS MUST BE PROTECTED, INCLUDING RETENTION ON-SITE OF NATIVE PLANT SPECIES, SUCH AS HYDRIC MULCHING AND OTHER PRACTICES AS SPECIFIED BY THE DISTRICT. MUST BE USED ON SLOPES OF 3:1 (H) OR STEEPER TO PROVIDE ADEQUATE STABILIZATION.
- FINAL SITE STABILIZATION MEASURES MUST BE INSTALLED AT LEAST SIX INCHES OF TOPSOIL (WITH A MINIMUM OF 1.00 KILOPASCALS OR 200 POUNDS PER SQUARE INCH) IN THE UPPER 12 INCHES OF THE SOIL PROFILE WHILE TREATMENT WHEREVER TOPSOIL HAS BEEN REMOVED.
- CONSTRUCTION SITE WASTE SUCH AS DISCARDED BUILDING MATERIALS, CONCRETE TRUCK WASHOUT, AND OTHER WASTE MUST BE STORED IN A DEDICATED AREA AND MUST BE MAINTAINED UNTIL COMPLETION OF CONSTRUCTION AND VEGETATION IS ESTABLISHED SUFFICIENTLY TO ENSURE STABILITY OF THE SITE, AS DETERMINED BY THE DISTRICT. SEDIMENT CONTROL BMPs MUST BE REMOVED UPON FINAL STABILIZATION OF SOIL SURFACES COMPACTED DURING CONSTRUCTION AND REMAINING PERVIOUS UPON COMPLETION OF CONSTRUCTION MUST BE DECOMPACTED TO ACHIEVE A SOIL COMPACTION TESTING PRESSURE OF LESS THAN 1,400 KILOPASCALS OR 200 POUNDS PER SQUARE INCH IN THE UPPER 12 INCHES OF THE SOIL PROFILE WHILE ALL DISTURBED AREAS MUST BE STABILIZED WITHIN 7 CALENDAR DAYS AFTER LAND DISTURBING WORK HAS COMPLETED.
- TEMPORARY OR PERMANENTLY CEASED ON A PROPERTY THAT DRAINS TO AN IMPAIRED WATER, WITHIN 14 DAYS ELSEWHERE. THE CONTRACTOR MUST AT A MINIMUM, INSPECT, MAINTAIN AND REPAIR ALL DISTURBED SURFACES AND ALL EROSION AND SEDIMENT CONTROL FACILITIES AND SOIL STABILIZATION MEASURES EVERY DAY WORKS PERFORMED ON THE SITE AND AT LEAST WEEKLY UNTIL LAND-DISTURBING ACTIVITY HAS CEASED. THEREAFTER, THE PERMITTEE MUST PERFORM THESE RESPONSIBILITIES AT LEAST WEEKLY UNTIL VEGETATIVE COVER IS ESTABLISHED TO THE POINT WHERE IT WILL MAINTAIN A LOS OF ACTIVITIES UNDER THIS SECTION FOR INSPECTION BY THE DISTRICT ON REQUEST.
- NO ACTIVITY AFFECTING THE BED OR BANK OF WETLAND 1 MAY BE CONDUCTED BETWEEN APRIL 1 AND JUNE 30 TO MINIMIZE IMPACTS ON FISH SPAWNING AND MIGRATION.

THE FOLLOWING DOCUMENTS ARE CONSIDERED PART OF THE SWPPP:

- PLAN AND PROFILE PLAN SHEETS: 18 - 25
- EROSION CONTROL PLAN AND TMDL ESTABLISHMENT: 10 - 14
- DETAIL PLAN SHEETS: 20 - 26
- SWPPP NOTE AND DETAIL SHEETS: 15 - 17
- PROJECT SPECIFICATIONS
- PROJECT BID FORM

TEMPORARY BMP DESIGN FACTORS:

- EROSION PREVENTION AND SEDIMENT CONTROL BMPs MUST BE DESIGNED TO ACCOUNT FOR THE EXPECTED AMOUNT, FREQUENCY, INTENSITY, AND DURATION OF PRECIPITATION
- THE NATURE OF STORMWATER RUNOFF AND RUN-ON AT THE SITE, INCLUDING FACTORS SUCH AS EXPECTED SOIL MOISTURE, VELOCITY, AND PEAK FLOW RATES TO MINIMIZE DISCHARGE OF POLLUTANTS IN THE STORMWATER VOLUME, VELOCITY, AND PEAK FLOW RATES TO MINIMIZE DISCHARGE OF POLLUTANTS IN DISCHARGE POINTS
- THE RANGE OF SOIL PARTICLE SIZES EXPECTED TO BE PRESENT.

TEMPORARY SEDIMENT BASINS:

TEMPORARY SEDIMENT BASINS ARE NOT ANTICIPATED TO BE REQUIRED TO MEET THE CONDITIONS OF THE PERMIT. PERMANENT STORMWATER MANAGEMENT SYSTEMS ARE NOT REQUIRED AS PART OF THE PROJECT TO MEET THE REQUIREMENTS OF THE NPDES GENERAL STORMWATER PERMIT FOR CONSTRUCTION ACTIVITY FOR THIS PROJECT. REFER TO PROJECT SUMMARY FOR ADDITIONAL INFORMATION.

PERMANENT STORMWATER MANAGEMENT WILL BE REQUIRED TO MEET RILEY PURGATORY BLUFF CREEK WATERSHED DISTRICT RATE CONTROL, VOLUME CONTROL, AND WATER QUALITY REQUIREMENTS.

THE CONTRACTOR IS RESPONSIBLE FOR ALL EROSION PREVENTION MEASURES FOR THE PROJECT.

EROSION PREVENTION MEASURES SHOWN ON PLANS ARE THE ABSOLUTE MINIMUM REQUIREMENTS. THE CONTRACTOR SHALL IMPLEMENT ADDITIONAL EROSION PREVENTION MEASURES AS NECESSARY TO PROPERLY MANAGE THE PROJECT AREA AND TO MINIMIZE THE DISCHARGE OF POLLUTANTS IN STORMWATER FROM CONSTRUCTION ACTIVITIES.

THE CONTRACTOR SHALL PLAN AND IMPLEMENT APPROPRIATE CONSTRUCTION PRACTICES AND CONSTRUCTION PHASING TO MINIMIZE EROSION AND RETAIN VEGETATION WHENEVER POSSIBLE.

THE PERMITTEE SHALL DELINEATE AREAS NOT TO BE DISTURBED. PERMITTEES MUST MINIMIZE THE NEED FOR DISTURBANCE OF PORTIONS OF THE PROJECT WITH STEEP SLOPES, WHEN STEEP SLOPES MUST BE DISTURBED, PERMITTEES MUST USE TECHNIQUES SUCH AS PHASING AND STABILIZATION PRACTICES DESIGNED FOR STEEP SLOPES.

CONTRACTOR MUST PHASE AND INCORPORATE STORMWATER MANAGEMENT PRINCIPLES AS THE CONSTRUCTION PROGRESSES. UNLESS INFEASIBLE, TEMPORARY OR PERMANENT WET SEDIMENTATION BASINS (WHEN REQUIRED, SEE SECTION 14 AND 19) SHOULD BE CONSTRUCTED AS A FIRST STEP IN THE PROCESS AND STORMWATER REQUIRED TO THESE.

SEH Project #	H03171654	Revision Issue	Discussed	Row #	.
Drawn By	JEN	Revision Issue	Discussed	Date	.
Designed By	JEN	 90% PRELIMINARY			
Checked By	JEN				
 LAKE ANN PRESERVE IMPROVEMENTS STORM WATER POLLUTION PREVENTION PLAN					
CHANHASSEN, MN L08RNF00 4/28/24					

EROSION PREVENTION MEASURES AND TIMING (CONT.):
 1. THE CONTRACTOR SHALL STABILIZE OR COVER ALL EXPOSED SOILS IMMEDIATELY TO LIMIT SOIL EROSION. IN NO CASE SHALL ANY EXPOSED AREA, INCLUDING STOCK PILES, HAVE EXPOSED SOILS FOR MORE THAN 7 DAYS WITHOUT PROVIDING TEMPORARY OR PERMANENT STABILIZATION. STABILIZATION MUST BE COMPLETED WITHIN 7 DAYS AFTER CONSTRUCTION ACTIVITY HAS CEASED. TEMPORARY STOCKPILES WITHOUT SIGNIFICANT CLAY, SILT, OR ORGANIC COMPONENTS DO NOT REQUIRE STABILIZATION.
 2. DRAINAGE PATHS, DITCHES, AND/OR SWALES SHALL HAVE TEMPORARY OR PERMANENT STABILIZATION WITHIN 24 HOURS OF CONNECTING TO SURFACE WATER OR 24 HOURS AFTER CONSTRUCTION ACTIVITY IN THE DITCH/SWALE HAS TEMPORARILY OR PERMANENTLY CEASED.
 3. THE CONTRACTOR SHALL COMPLETE THE STABILIZATION OF ALL EXPOSED SOILS WITHIN 24 HOURS THAT LIE WITHIN 200 FEET OF PUBLIC WATERS PROMULGATED WORKIN WATER RESTRICTIONS BY THE MN DNR DURING SPECIFIED FISH SPAWNING TIMES.
 4. THE CONTRACTOR SHALL IMPLEMENT EROSION CONTROL BMPs AND VELOCITY DISSIPATION DEVICES ALONG CONSTRUCTED STORMWATER CONVEYANCE CHANNELS AND OUTLETS.
 5. PERMITTEES MUST STABILIZE THE NORMAL WETTED PERIMETER OF THE LAST 200 LINEAR FEET OF TEMPORARY OR PERMANENT DRAINAGE DITCHES OR SWALES THAT DRAIN WATER FROM THE SITE WITHIN 24 HOURS AFTER REMAINING PORTIONS OF TEMPORARY OR PERMANENT DITCHES OR SWALES WITHIN 14 CALENDAR DAYS (7 DAYS FOR SITES DISCHARGING TO SPECIAL OR IMPAIRED WATERS, SEE SECTION 36) AFTER CONNECTING TO A SURFACE WATER OR PROPERTY EDGE AND CONSTRUCTION IN THAT PORTION OF THE DITCH TEMPORARILY OR PERMANENTLY CEASES.
 6. THE CONTRACTOR SHALL NOT UTILIZE HYDROMULCH, TACKIFIER, POLYACRYLAMIDE OR SIMILAR EROSION PREVENTION PRACTICES AS A FORM OF STABILIZATION FOR TEMPORARY OR PERMANENT DRAINAGE DITCHES OR SWALE SECTION WITH A CONTINUOUS SLOPE OF GREATER THAN 2 PERCENT.
 7. THE CONTRACTOR SHALL ENSURE PIPE OUTLETS HAVE TEMPORARY OR PERMANENT ENERGY DISSIPATION WITHIN 24 HOURS OF CONNECTION TO SURFACE WATER.
 8. THE CONTRACTOR SHALL DIRECT DISCHARGES FROM BMPs TO VEGETATED AREAS TO INCREASE SEDIMENT REMOVAL AND MAXIMIZE STORMWATER INFILTRATION. VELOCITY DISSIPATION DEVICES MUST BE USED TO PREVENT EROSION WHEN DIRECTING STORMWATER TO VEGETATED AREAS.
 9. SEDIMENT CONTROL MEASURES AND TIMING:
 10. THE CONTRACTOR IS RESPONSIBLE FOR ALL SEDIMENT CONTROL MEASURES FOR THE PROJECT.
 11. SEDIMENT CONTROL MEASURES SHOWN ON PLANS ARE THE ABSOLUTE MINIMUM REQUIREMENTS.
 12. THE CONTRACTOR SHALL IMPLEMENT ADDITIONAL SEDIMENT CONTROL MEASURES AS NECESSARY TO PROPERLY MANAGE THE PROJECT AREA.
 13. THE CONTRACTOR SHALL ENSURE SEDIMENT CONTROL MEASURES ARE ESTABLISHED ON ALL DOWN GRADIENT PERIMETERS BEFORE ANY UPGRADE/LAND DISTURBING ACTIVITIES BEGIN. THESE MEASURES SHALL REMAIN IN PLACE UNTIL FINAL STABILIZATION HAS BEEN ESTABLISHED.
 14. A FLOATING SILT CURTAIN PLACED IN THE WATER IS NOT A SEDIMENT CONTROL BMP EXCEPT WHEN WORKING ON A SHORELINE OR BELOW THE WATERLINE. IMMEDIATELY AFTER THE CONSTRUCTION ACTIVITY IS COMPLETE, PERMITTEES MUST INSTALL AN UPLAND PERIMETER CONTROL PRACTICE IF EXPOSED SOILS STILL DRAIN TO A SURFACE WATER.
 15. THE CONTRACTOR SHALL ENSURE SEDIMENT CONTROL PRACTICES REMOVED OR ADJUSTED FOR SHORT-TERM ACTIVITIES BE RE-INSTALLED IMMEDIATELY AFTER THE SHORT-TERM ACTIVITY HAS COMPLETED. PERMITTEES MUST INSTALL AN UPLAND PERIMETER CONTROL PRACTICE BEFORE THE NEXT PRECIPITATION EVENT EVEN IF THE SHORT-TERM ACTIVITY IS NOT COMPLETE.
 16. THE CONTRACTOR SHALL ENSURE STORM DRAIN INLETS ARE PROTECTED BY APPROPRIATE BMPs DURING CONSTRUCTION TO PREVENT POTENTIAL FOR DISCHARGING TO THE INLET HAVE BEEN STABILIZED.
 17. THE CONTRACTOR MUST PROVIDE SILT FENCE OR OTHER EFFECTIVE SEDIMENT CONTROL AT THE BASE OF THE RECEIVING WATER. SEDIMENT CONTROL MEASURES SHALL BE MAINTAINED THROUGHOUT CONSTRUCTION. SOILS MUST BE MAINTAINED IN ACCORDANCE WITH SECTION 3.6 OF THE NPDES PERMIT MNR100001. CONTRACTOR SHALL INITIATE TEMPORARY OR PERMANENT STABILIZATION OF SEDIMENT CONTROL BMPs MADE OF SOIL WITHIN 24 HOURS OF CONSTRUCTION. PERMANENT STABILIZATION OF SEDIMENT CONTROL BMPs MADE OF SOIL WITHIN 24 HOURS AND AREAS CONSIDERED ENVIRONMENTALLY SENSITIVE.
 18. THE CONTRACTOR SHALL ENSURE VELOCITY TRACKING BE MAINTAINED WITH EFFECTIVE BARRS. WHERE THE BMPs FAIL TO PREVENT SEDIMENT FROM TRACKING ONTO THE RECEIVING WATER, THE CONTRACTOR SHALL CONDUCT STREET SWEEPING, IN ADDITION TO VEHICLE TRACKING BMPs, TO REMOVE ALL TRACKED SEDIMENT.
 19. THE CONTRACTOR SHALL IMPLEMENT CONSTRUCTION PRACTICES TO MINIMIZE SOIL COMPACTION.
 20. THE CONTRACTOR SHALL ENSURE ALL CONSTRUCTION ACTIVITY REMAIN WITHIN PROJECT LIMITS AND THAT ALL IDENTIFIED RECEIVING WATER BUFFERS ARE MAINTAINED.

SEEDING CONTROL MEASURES AND TIMING (CONT.):
 1. THE CONTRACTOR SHALL NOT UTILIZE SEDIMENT CONTROL CHEMICALS ON SITE.
 2. ALL INSPECTIONS, MAINTENANCE, REPAIRS, REPLACEMENTS, AND REMOVAL OF BMPs IS TO BE CONSIDERED INCIDENTAL TO THE BMP BID ITEMS.
 3. THE PERMITTEES IS RESPONSIBLE FOR COMPLETING SITE INSPECTIONS, AND BMP MAINTENANCE TO ENSURE COMPLIANCE WITH THE PERMIT REQUIREMENTS.
 4. THE PERMITTEES SHALL INSPECT THE CONSTRUCTION SITE ONCE EVERY 7 DAYS DURING ACTIVE CONSTRUCTION AND WITHIN 24 HOURS AFTER A RAINFALL EVENT GREATER THAN 0.5 INCHES IN 24 HOURS.
 5. PERMITTEE MAY ADJUST THE INSPECTION SCHEDULE DESCRIBED AS FOLLOWS:
 A. INSPECTIONS OF AREAS WITH PERMANENT COVER CAN BE REDUCED TO ONCE PER MONTH, EVEN IF CONSTRUCTION ACTIVITY CONTINUES ON OTHER PORTIONS OF THE SITE, OR
 B. WHERE SITES HAVE PERMANENT COVER ON ALL EXPOSED SOIL AND NO CONSTRUCTION ACTIVITY FOR 12 MONTHS, MAY BE SUSPENDED COMPLETELY UNTIL CONSTRUCTION ACTIVITY RESUMES. THE NPCA MAY REQUIRE INSPECTIONS TO BE RESUME IF CONDITIONS WARRANT; OR
 C. WHERE CONSTRUCTION ACTIVITY HAS BEEN SUSPENDED DUE TO FROZEN GROUND CONDITIONS, INSPECTIONS RESUMING CONSTRUCTION, WHOEVER COMES FIRST, WITHIN 24 HOURS OF RAINFALL OCCURRING, OR UPON ANY INSPECTION TO VERIFY PERMANENT COVER IS MAINTAINED.
 D. FOR PROJECTS WHERE A POLLINATOR HABITAT OR NATIVE PRAIRIE TYPE VEGETATED COVERS BEING RESTORED, THE CONTRACTOR SHALL PROVIDE PERMANENT COVER, AT LEAST 24 MONTHS AND SIGNIFICANT EROSION PROBLEMS ARE OBSERVED, INSPECTIONS MAY BE SUSPENDED COMPLETELY UNTIL THE TERMINATION REQUIREMENTS IN SECTION 13 OF THE NPDES PERMIT MNR100001 HAVE BEEN MET.
 6. THE PERMITTEES SHALL DOCUMENT A WRITTEN SUMMARY OF ALL INSPECTIONS AND MAINTENANCE ACTIVITIES CONDUCTED WITHIN 24 HOURS OF OCCURRENCE. RECORDS OF EACH ACTIVITY SHALL INCLUDE THE FOLLOWING:
 • DATE AND TIME OF INSPECTIONS;
 • NAME OF INSPECTOR;
 • FINDINGS AND RECOMMENDATIONS FOR CORRECTIVE ACTIONS IF NECESSARY;
 • DATE AND AMOUNT OF RAINFALL EVENTS;
 • SOILS, OIL SHEEN, AND OTHER OBVIOUS INDICATORS OF POLLUTANTS; AND
 • ANY AMENDMENTS TO THE SWPPP PROPOSED AS A RESULT OF THE INSPECTION MUST BE DOCUMENTED AS ALL PHOTOGRAPHS OF DEWATERING ACTIVITIES AND DOCUMENTATION OF NUISANCE CONDITIONS RESULTING FROM DEWATERING ACTIVITIES AS DESCRIBED IN SECTION 10 OF THE NPDES PERMIT MNR100001.
 7. THE PERMITTEES SHALL SUBMIT A COPY OF THE WRITTEN INSPECTIONS TO THE ENGINEER AND OWNER ON A MONTHLY BASIS. IF MONTHLY INSPECTION REPORTS ARE NOT SUBMITTED, MONTHLY PAYMENTS MAY BE HELD.
 8. THE CONTRACTOR SHALL DOCUMENT AMENDMENTS TO THE SWPPP AS A RESULT OF INSPECTIONS WITHIN 7 DAYS.
 9. THE CONTRACTOR SHALL KEEP THE SWPPP, ALL INSPECTION REPORTS, AND AMENDMENTS ONSITE. THE CONTRACTOR SHALL DESIGNATE A SPECIFIC ONSITE LOCATION TO KEEP THE RECORDS
 10. THE CONTRACTOR IS RESPONSIBLE FOR THE OPERATION AND MAINTENANCE OF TEMPORARY AND PERMANENT WATER QUALITY BMPs, AS WELL AS EROSION AND SEDIMENT CONTROL BMPs.
 11. THE CONTRACTOR SHALL INSPECT EROSION PREVENTION AND SEDIMENT CONTROL BMPs TO ENSURE INTEGRITY AND EFFECTIVENESS. ALL NONFUNCTIONAL BMPs SHALL BE REPAIRED, REPLACED, OR SUPPLEMENTED WITH FUNCTIONAL BMPs WITHIN 24 HOURS OF FINDING. THE CONTRACTOR SHALL INVESTIGATE AND COMPLY WITH THE FOLLOWING INSPECTION AND MAINTENANCE REQUIREMENTS:
 12. PERIMETER CONTROL DEVICES, INCLUDING SILT FENCE SHALL BE REPAIRED, OR REPLACED, WHEN THEY BECOME NONFUNCTIONAL OR THE SEDIMENT REACHES 1/2 OF THE DEVICE HEIGHT. THESE REPAIRS SHALL BE MADE WITHIN 24 HOURS OF DISCOVERY.
 13. TEMPORARY AND PERMANENT SEDIMENT BASINS SHALL BE DRAINED AND THE SEDIMENT REMOVED WHEN THE DEPTH OF SEDIMENT COLLECTED IN THE BASIN REACHES 1/2 THE STORAGE VOLUME. DRAINAGE AND REMOVAL MUST BE COMPLETED WITHIN 72 HOURS OF DISCOVERY.
 14. DURING EACH INSPECTION, CONTRACTOR MUST INSPECT AREAS ADJACENT TO THE PROJECT SURFACE WATERS, INCLUDING DRAINAGE DITCHES AND CONVEYANCE SYSTEMS BUT NOT CURB AND GUTTER SYSTEMS. FOR EVIDENCE OF EROSION AND SEDIMENT DEPOSITION, CONTRACTOR MUST REMOVE ALL DELTAS AND SEDIMENTS AND OTHER DRAINAGE SYSTEMS AND RESTABILIZE THE AREAS WHERE SEDIMENT REMOVAL RESULTS IN EXPOSED SOIL. CONTRACTOR MUST COMPLETE REMOVAL AND STABILIZATION WITHIN SEVEN (7) CALENDAR DAYS OF DISCOVERY UNLESS PREVENTED BY LEGAL, INSOLUBLE, OR OTHERWISE UNREMOVABLE DEPOSITS. CONTRACTOR MUST USE ALL NECESSARY MEASURES TO PREVENT EROSION, INCLUDING REPAIRS, REPLACEMENTS, AND STABILIZATION WITHIN SEVEN (7) DAYS OF OBTAINING ACCESS. CONTRACTOR IS RESPONSIBLE FOR CONTACTING ALL LOCAL, REGIONAL, STATE AND FEDERAL AUTHORITIES AND RECEIVING ANY APPLICABLE PERMITS, PRIOR TO CONDUCTING ANY WORK IN SURFACE WATERS.
 15. CONSTRUCTION SITE VEHICLE EXIT LOCATIONS SHALL BE INSPECTED DAILY FOR EVIDENCE OF SEDIMENT TRACKING ONTO PAVED SURFACES. TRACKED SEDIMENT MUST BE REMOVED FROM ALL PAVED SURFACES WITHIN 24 HOURS OF DISCOVERY.
 16. IF SEDIMENT ESCAPES THE CONSTRUCTION SITE, OFF-SITE ACCUMULATIONS OF SEDIMENT MUST BE REMOVED IN A MAJOR AND AT A FREQUENCY SUFFICIENT TO MINIMIZE OFF-SITE IMPACTS.
 17. EROSION PREVENTION BMP SUMMARY:
 18. SEE EROSION AND SEDIMENT CONTROL PLAN SHEET AND BID FORM FOR TYPE, LOCATION, AND QUANTITY OF EROSION PREVENTION BMPs.
 19. SEDIMENT CONTROL BMP SUMMARY:
 20. SEE EROSION AND SEDIMENT CONTROL PLAN SHEETS AND BID FORM FOR TYPE, LOCATION, AND QUANTITY OF SEDIMENT CONTROL BMPs.

DEWATERING AND BASIN DRAINING ACTIVITIES:
 1. THE CONTRACTOR IS RESPONSIBLE FOR ADHERING TO ALL DEWATERING AND SURFACE DRAINAGE REGULATIONS.
 2. CONTRACTOR MUST NOT CAUSE NUISANCE CONDITIONS (SEE MINN. R. 7050.0210, SUBP. 2) IN SURFACE WATERS FROM DEWATERING AND BASIN DRAINING (E.G., PUMPED DISCHARGES, TRENCH/DITCH CUTS FOR DRAINAGE) DISCHARGES. CONTRACTOR SHALL TAKE ALL NECESSARY PRECAUTIONS TO PREVENT NUISANCE CONDITIONS, INCLUDING TO A SEDIMENT CONTROL (E.G., GRASSY OR WOODEN) UP AND AREAS OF THE SITE TO INFILTRATE DEWATERING WATER BEFORE DISCHARGE. CONTRACTOR ARE PROHIBITED FROM USING RECEIVING WATERS AS PART OF THE TREATMENT AREA. CONTRACTOR MUST VISUALLY CHECK AND PHOTOGRAPH THE DISCHARGE AT THE BEGINNING AND END OF EACH DEWATERING AND BASIN DRAINING ACTIVITY. TREATMENT HAS BEEN OBTAINED AND NUISANCE CONDITIONS WILL NOT RESULT FROM THE DISCHARGE.
 3. IF NUISANCE CONDITIONS RESULT FROM THE DISCHARGE, CONTRACTOR MUST CEASE DEWATERING IMMEDIATELY AND TAKE ALL NECESSARY PRECAUTIONS TO PREVENT NUISANCE CONDITIONS. CONTRACTOR SHALL NOT DISCHARGE INTO A SENSITIVE LOCATION (E.G., A SEDIMENT PLUME IN THE DISCHARGE OR THE DISCHARGE APPEARS CLOUDY, OR OPAQUE, OR HAS A VISIBLE OIL FILM, OR HAS A QUANTITATIVE HABITAT DEGRADATION THAT CAN BE IDENTIFIED BY AN OBSERVER.
 4. CONTRACTOR MUST INSPECT AND PHOTOGRAPH DEWATERING DISCHARGES AT THE BEGINNING AND AT LEAST ONCE EVERY 24 HOURS DURING OPERATION. DEWATERING DISCHARGES THAT ONLY LAST FOR MINUTES AS OPPOSED TO HOURS AND DO NOT REACH A SURFACE WATER, DO NOT REQUIRE PHOTOGRAPHS OR DOCUMENTATION.
 5. DISCHARGE THAT CONTAINS OIL OR GREASE MUST BE TREATED WITH AN OIL-WATER SEPARATOR OR SUITABLE FILTRATION DEVICE PRIOR TO DISCHARGE.
 6. BACKWASH WATER USED FOR FILTERING SHALL BE MAILED AWAY FOR DISPOSAL, RETURNED TO THE BEGINNING OF THE DEWATERING PROCESS, OR DISCHARGED INTO THE SURFACE WATER. CONTRACTOR SHALL NOT DISCHARGE BACKWASH WATER TO SURFACE WATER. CONTRACTOR SHALL REPLACE AND CLEAN FILTRATION DEVICES WHEN REQUIRED TO MAINTAIN ADEQUATE FUNCTION.
 7. POLLUTION PREVENTION MANAGEMENT MEASURES:
 8. THE CONTRACTOR SHALL BE RESPONSIBLE FOR ALL POLLUTION PREVENTION MANAGEMENT MEASURES.
 9. ALL POLLUTION PREVENTION MEASURES ARE CONSIDERED INCIDENTAL TO THE MOBILIZATION BID ITEM, UNLESS OTHERWISE NOTED.
 10. THE CONTRACTOR IS RESPONSIBLE FOR THE PROPER DISPOSAL, IN COMPLIANCE WITH MPCA DISPOSAL REQUIREMENTS, OF ALL HAZARDOUS MATERIALS, SOLID WASTE, AND PRODUCT ONSITE.
 11. THE CONTRACTOR SHALL ENSURE CONSTRUCTION MATERIALS THAT HAVE THE POTENTIAL TO LEAK POLLUTANTS ARE KEPT UNDER COVER TO PREVENT THE DISCHARGE OF POLLUTANTS.
 12. THE CONTRACTOR SHALL ENSURE PESTICIDES, HERBICIDES, INSECTICIDES, FERTILIZERS, TREATMENT CHEMICALS, AND LANDSCAPE MATERIALS ARE COVERED TO PREVENT THE DISCHARGE OF POLLUTANTS.
 13. THE CONTRACTOR SHALL ENSURE HAZARDOUS MATERIALS AND TOXIC WASTE IS PROPERLY STORED IN SEALED CONTAINERS TO PREVENT SPILLS, LEAKS, OR OTHER DISCHARGE. STORAGE AND DISPOSAL OF HAZARDOUS WASTE OR HAZARDOUS MATERIALS MUST BE IN COMPLIANCE WITH MINN. R. CH. 7045 INCLUDING SECONDARY CONTAINMENT AS APPLICABLE.
 14. THE CONTRACTOR SHALL ENSURE ASPHALT SUBSTANCES USED ONSITE SHALL BE APPLIED IN ACCORDANCE WITH MANUFACTURER'S RECOMMENDATIONS.
 15. THE CONTRACTOR SHALL ENSURE PAINT CONTAINERS AND CURING COMPOUNDS SHALL BE TIGHTLY SEALED AND STORED WHEN NOT REQUIRED FOR USE. EXCESS PAINT AND/OR CURING COMPOUNDS SHALL NOT BE DISCHARGED INTO THE STORM SEWER SYSTEM AND SHALL BE PROPERLY DISPOSED OF ACCORDING TO MANUFACTURER'S INSTRUCTION.
 16. THE CONTRACTOR SHALL ENSURE SOILD WASTE BE STORED, COLLECTED AND DISPOSED OF PROPERLY IN COMPLIANCE WITH MINN. R. CH. 7036.
 17. THE CONTRACTOR SHALL ENSURE POTABLE TOILETS ARE POSITIONED SO THAT THEY ARE SECURE AND WILL NOT BE TIPPED OR KNOCKED OVER. SANITARY WASTE MUST BE DISPOSED OF PROPERLY IN ACCORDANCE WITH MINN. R. CH. 7041.
 18. THE CONTRACTOR SHALL MONITOR ALL VEHICLES ONSITE FOR LEAKS AND RECEIVE REGULAR PREVENTION MAINTENANCE TO REDUCE THE CHANCE OF LEAKAGE.
 19. THE CONTRACTOR SHALL ENSURE WASHOUT WASTE MUST CONTACT THE GROUND AND BE PROPERLY DISPOSED OF IN COMPLIANCE WITH MPCA RULES.
 20. THE CONTRACTOR SHALL INCLUDE SPILL KITS WITH ALL FUELING SOURCES AND MAINTENANCE ACTIVITIES. SECONDARY CONTAINMENT MEASURES SHALL BE INSTALLED AND MAINTAINED BY THE CONTRACTOR.
 21. THE CONTRACTOR SHALL ENSURE SPILLS ARE CONTAINED AND CLEANED UP IMMEDIATELY UPON DISCOVERY. SPILLS LARGE ENOUGH TO REACH THE STORM WATER CONVEYANCE SYSTEM SHALL BE REPORTED TO THE MINNESOTA DUTY OFFICER AT 1.800.422.0798.

LAKE ANN PRESERVE IMPROVEMENTS
 1. THE CONTRACTOR SHALL NOT UTILIZE SEDIMENT CONTROL CHEMICALS ON SITE.
 2. ALL INSPECTIONS, MAINTENANCE, REPAIRS, REPLACEMENTS, AND REMOVAL OF BMPs IS TO BE CONSIDERED INCIDENTAL TO THE BMP BID ITEMS.
 3. THE PERMITTEES IS RESPONSIBLE FOR COMPLETING SITE INSPECTIONS, AND BMP MAINTENANCE TO ENSURE COMPLIANCE WITH THE PERMIT REQUIREMENTS.
 4. THE PERMITTEES SHALL INSPECT THE CONSTRUCTION SITE ONCE EVERY 7 DAYS DURING ACTIVE CONSTRUCTION AND WITHIN 24 HOURS AFTER A RAINFALL EVENT GREATER THAN 0.5 INCHES IN 24 HOURS.
 5. PERMITTEE MAY ADJUST THE INSPECTION SCHEDULE DESCRIBED AS FOLLOWS:
 A. INSPECTIONS OF AREAS WITH PERMANENT COVER CAN BE REDUCED TO ONCE PER MONTH, EVEN IF CONSTRUCTION ACTIVITY CONTINUES ON OTHER PORTIONS OF THE SITE, OR
 B. WHERE SITES HAVE PERMANENT COVER ON ALL EXPOSED SOIL AND NO CONSTRUCTION ACTIVITY FOR 12 MONTHS, MAY BE SUSPENDED COMPLETELY UNTIL CONSTRUCTION ACTIVITY RESUMES. THE NPCA MAY REQUIRE INSPECTIONS TO BE RESUME IF CONDITIONS WARRANT; OR
 C. WHERE CONSTRUCTION ACTIVITY HAS BEEN SUSPENDED DUE TO FROZEN GROUND CONDITIONS, INSPECTIONS RESUMING CONSTRUCTION, WHOEVER COMES FIRST, WITHIN 24 HOURS OF RAINFALL OCCURRING, OR UPON ANY INSPECTION TO VERIFY PERMANENT COVER IS MAINTAINED.
 D. FOR PROJECTS WHERE A POLLINATOR HABITAT OR NATIVE PRAIRIE TYPE VEGETATED COVERS BEING RESTORED, THE CONTRACTOR SHALL PROVIDE PERMANENT COVER, AT LEAST 24 MONTHS AND SIGNIFICANT EROSION PROBLEMS ARE OBSERVED, INSPECTIONS MAY BE SUSPENDED COMPLETELY UNTIL THE TERMINATION REQUIREMENTS IN SECTION 13 OF THE NPDES PERMIT MNR100001 HAVE BEEN MET.
 6. THE PERMITTEES SHALL DOCUMENT A WRITTEN SUMMARY OF ALL INSPECTIONS AND MAINTENANCE ACTIVITIES CONDUCTED WITHIN 24 HOURS OF OCCURRENCE. RECORDS OF EACH ACTIVITY SHALL INCLUDE THE FOLLOWING:
 • DATE AND TIME OF INSPECTIONS;
 • NAME OF INSPECTOR;
 • FINDINGS AND RECOMMENDATIONS FOR CORRECTIVE ACTIONS IF NECESSARY;
 • DATE AND AMOUNT OF RAINFALL EVENTS;
 • SOILS, OIL SHEEN, AND OTHER OBVIOUS INDICATORS OF POLLUTANTS; AND
 • ANY AMENDMENTS TO THE SWPPP PROPOSED AS A RESULT OF THE INSPECTION MUST BE DOCUMENTED AS ALL PHOTOGRAPHS OF DEWATERING ACTIVITIES AND DOCUMENTATION OF NUISANCE CONDITIONS RESULTING FROM DEWATERING ACTIVITIES AS DESCRIBED IN SECTION 10 OF THE NPDES PERMIT MNR100001.
 7. THE PERMITTEES SHALL SUBMIT A COPY OF THE WRITTEN INSPECTIONS TO THE ENGINEER AND OWNER ON A MONTHLY BASIS. IF MONTHLY INSPECTION REPORTS ARE NOT SUBMITTED, MONTHLY PAYMENTS MAY BE HELD.
 8. THE CONTRACTOR SHALL DOCUMENT AMENDMENTS TO THE SWPPP AS A RESULT OF INSPECTIONS WITHIN 7 DAYS.
 9. THE CONTRACTOR SHALL KEEP THE SWPPP, ALL INSPECTION REPORTS, AND AMENDMENTS ONSITE. THE CONTRACTOR SHALL DESIGNATE A SPECIFIC ONSITE LOCATION TO KEEP THE RECORDS
 10. THE CONTRACTOR IS RESPONSIBLE FOR THE OPERATION AND MAINTENANCE OF TEMPORARY AND PERMANENT WATER QUALITY BMPs, AS WELL AS EROSION AND SEDIMENT CONTROL BMPs.
 11. THE CONTRACTOR SHALL INSPECT EROSION PREVENTION AND SEDIMENT CONTROL BMPs TO ENSURE INTEGRITY AND EFFECTIVENESS. ALL NONFUNCTIONAL BMPs SHALL BE REPAIRED, REPLACED, OR SUPPLEMENTED WITH FUNCTIONAL BMPs WITHIN 24 HOURS OF FINDING. THE CONTRACTOR SHALL INVESTIGATE AND COMPLY WITH THE FOLLOWING INSPECTION AND MAINTENANCE REQUIREMENTS:
 12. PERIMETER CONTROL DEVICES, INCLUDING SILT FENCE SHALL BE REPAIRED, OR REPLACED, WHEN THEY BECOME NONFUNCTIONAL OR THE SEDIMENT REACHES 1/2 OF THE DEVICE HEIGHT. THESE REPAIRS SHALL BE MADE WITHIN 24 HOURS OF DISCOVERY.
 13. TEMPORARY AND PERMANENT SEDIMENT BASINS SHALL BE DRAINED AND THE SEDIMENT REMOVED WHEN THE DEPTH OF SEDIMENT COLLECTED IN THE BASIN REACHES 1/2 THE STORAGE VOLUME. DRAINAGE AND REMOVAL MUST BE COMPLETED WITHIN 72 HOURS OF DISCOVERY.
 14. DURING EACH INSPECTION, CONTRACTOR MUST INSPECT AREAS ADJACENT TO THE PROJECT SURFACE WATERS, INCLUDING DRAINAGE DITCHES AND CONVEYANCE SYSTEMS BUT NOT CURB AND GUTTER SYSTEMS. FOR EVIDENCE OF EROSION AND SEDIMENT DEPOSITION, CONTRACTOR MUST REMOVE ALL DELTAS AND SEDIMENTS AND OTHER DRAINAGE SYSTEMS AND RESTABILIZE THE AREAS WHERE SEDIMENT REMOVAL RESULTS IN EXPOSED SOIL. CONTRACTOR MUST COMPLETE REMOVAL AND STABILIZATION WITHIN SEVEN (7) CALENDAR DAYS OF DISCOVERY UNLESS PREVENTED BY LEGAL, INSOLUBLE, OR OTHERWISE UNREMOVABLE DEPOSITS. CONTRACTOR MUST USE ALL NECESSARY MEASURES TO PREVENT EROSION, INCLUDING REPAIRS, REPLACEMENTS, AND STABILIZATION WITHIN SEVEN (7) DAYS OF OBTAINING ACCESS. CONTRACTOR IS RESPONSIBLE FOR CONTACTING ALL LOCAL, REGIONAL, STATE AND FEDERAL AUTHORITIES AND RECEIVING ANY APPLICABLE PERMITS, PRIOR TO CONDUCTING ANY WORK IN SURFACE WATERS.
 15. CONSTRUCTION SITE VEHICLE EXIT LOCATIONS SHALL BE INSPECTED DAILY FOR EVIDENCE OF SEDIMENT TRACKING ONTO PAVED SURFACES. TRACKED SEDIMENT MUST BE REMOVED FROM ALL PAVED SURFACES WITHIN 24 HOURS OF DISCOVERY.
 16. IF SEDIMENT ESCAPES THE CONSTRUCTION SITE, OFF-SITE ACCUMULATIONS OF SEDIMENT MUST BE REMOVED IN A MAJOR AND AT A FREQUENCY SUFFICIENT TO MINIMIZE OFF-SITE IMPACTS.
 17. EROSION PREVENTION BMP SUMMARY:
 18. SEE EROSION AND SEDIMENT CONTROL PLAN SHEET AND BID FORM FOR TYPE, LOCATION, AND QUANTITY OF EROSION PREVENTION BMPs.
 19. SEDIMENT CONTROL BMP SUMMARY:
 20. SEE EROSION AND SEDIMENT CONTROL PLAN SHEETS AND BID FORM FOR TYPE, LOCATION, AND QUANTITY OF SEDIMENT CONTROL BMPs.

STORM WATER POLLUTION PREVENTION PLAN
 1. THE CONTRACTOR IS RESPONSIBLE FOR ADHERING TO ALL DEWATERING AND SURFACE DRAINAGE REGULATIONS.
 2. CONTRACTOR MUST NOT CAUSE NUISANCE CONDITIONS (SEE MINN. R. 7050.0210, SUBP. 2) IN SURFACE WATERS FROM DEWATERING AND BASIN DRAINING (E.G., PUMPED DISCHARGES, TRENCH/DITCH CUTS FOR DRAINAGE) DISCHARGES. CONTRACTOR SHALL TAKE ALL NECESSARY PRECAUTIONS TO PREVENT NUISANCE CONDITIONS, INCLUDING TO A SEDIMENT CONTROL (E.G., GRASSY OR WOODEN) UP AND AREAS OF THE SITE TO INFILTRATE DEWATERING WATER BEFORE DISCHARGE. CONTRACTOR ARE PROHIBITED FROM USING RECEIVING WATERS AS PART OF THE TREATMENT AREA. CONTRACTOR MUST VISUALLY CHECK AND PHOTOGRAPH THE DISCHARGE AT THE BEGINNING AND END OF EACH DEWATERING AND BASIN DRAINING ACTIVITY. TREATMENT HAS BEEN OBTAINED AND NUISANCE CONDITIONS WILL NOT RESULT FROM THE DISCHARGE.
 3. IF NUISANCE CONDITIONS RESULT FROM THE DISCHARGE, CONTRACTOR MUST CEASE DEWATERING IMMEDIATELY AND TAKE ALL NECESSARY PRECAUTIONS TO PREVENT NUISANCE CONDITIONS. CONTRACTOR SHALL NOT DISCHARGE INTO A SENSITIVE LOCATION (E.G., A SEDIMENT PLUME IN THE DISCHARGE OR THE DISCHARGE APPEARS CLOUDY, OR OPAQUE, OR HAS A VISIBLE OIL FILM, OR HAS A QUANTITATIVE HABITAT DEGRADATION THAT CAN BE IDENTIFIED BY AN OBSERVER.
 4. CONTRACTOR MUST INSPECT AND PHOTOGRAPH DEWATERING DISCHARGES AT THE BEGINNING AND AT LEAST ONCE EVERY 24 HOURS DURING OPERATION. DEWATERING DISCHARGES THAT ONLY LAST FOR MINUTES AS OPPOSED TO HOURS AND DO NOT REACH A SURFACE WATER, DO NOT REQUIRE PHOTOGRAPHS OR DOCUMENTATION.
 5. DISCHARGE THAT CONTAINS OIL OR GREASE MUST BE TREATED WITH AN OIL-WATER SEPARATOR OR SUITABLE FILTRATION DEVICE PRIOR TO DISCHARGE.
 6. BACKWASH WATER USED FOR FILTERING SHALL BE MAILED AWAY FOR DISPOSAL, RETURNED TO THE BEGINNING OF THE DEWATERING PROCESS, OR DISCHARGED INTO THE SURFACE WATER. CONTRACTOR SHALL NOT DISCHARGE BACKWASH WATER TO SURFACE WATER. CONTRACTOR SHALL REPLACE AND CLEAN FILTRATION DEVICES WHEN REQUIRED TO MAINTAIN ADEQUATE FUNCTION.
 7. POLLUTION PREVENTION MANAGEMENT MEASURES:
 8. THE CONTRACTOR SHALL BE RESPONSIBLE FOR ALL POLLUTION PREVENTION MANAGEMENT MEASURES.
 9. ALL POLLUTION PREVENTION MEASURES ARE CONSIDERED INCIDENTAL TO THE MOBILIZATION BID ITEM, UNLESS OTHERWISE NOTED.
 10. THE CONTRACTOR IS RESPONSIBLE FOR THE PROPER DISPOSAL, IN COMPLIANCE WITH MPCA DISPOSAL REQUIREMENTS, OF ALL HAZARDOUS MATERIALS, SOLID WASTE, AND PRODUCT ONSITE.
 11. THE CONTRACTOR SHALL ENSURE CONSTRUCTION MATERIALS THAT HAVE THE POTENTIAL TO LEAK POLLUTANTS ARE KEPT UNDER COVER TO PREVENT THE DISCHARGE OF POLLUTANTS.
 12. THE CONTRACTOR SHALL ENSURE PESTICIDES, HERBICIDES, INSECTICIDES, FERTILIZERS, TREATMENT CHEMICALS, AND LANDSCAPE MATERIALS ARE COVERED TO PREVENT THE DISCHARGE OF POLLUTANTS.
 13. THE CONTRACTOR SHALL ENSURE HAZARDOUS MATERIALS AND TOXIC WASTE IS PROPERLY STORED IN SEALED CONTAINERS TO PREVENT SPILLS, LEAKS, OR OTHER DISCHARGE. STORAGE AND DISPOSAL OF HAZARDOUS WASTE OR HAZARDOUS MATERIALS MUST BE IN COMPLIANCE WITH MINN. R. CH. 7045 INCLUDING SECONDARY CONTAINMENT AS APPLICABLE.
 14. THE CONTRACTOR SHALL ENSURE ASPHALT SUBSTANCES USED ONSITE SHALL BE APPLIED IN ACCORDANCE WITH MANUFACTURER'S RECOMMENDATIONS.
 15. THE CONTRACTOR SHALL ENSURE PAINT CONTAINERS AND CURING COMPOUNDS SHALL BE TIGHTLY SEALED AND STORED WHEN NOT REQUIRED FOR USE. EXCESS PAINT AND/OR CURING COMPOUNDS SHALL NOT BE DISCHARGED INTO THE STORM SEWER SYSTEM AND SHALL BE PROPERLY DISPOSED OF ACCORDING TO MANUFACTURER'S INSTRUCTION.
 16. THE CONTRACTOR SHALL ENSURE SOILD WASTE BE STORED, COLLECTED AND DISPOSED OF PROPERLY IN COMPLIANCE WITH MINN. R. CH. 7036.
 17. THE CONTRACTOR SHALL ENSURE POTABLE TOILETS ARE POSITIONED SO THAT THEY ARE SECURE AND WILL NOT BE TIPPED OR KNOCKED OVER. SANITARY WASTE MUST BE DISPOSED OF PROPERLY IN ACCORDANCE WITH MINN. R. CH. 7041.
 18. THE CONTRACTOR SHALL MONITOR ALL VEHICLES ONSITE FOR LEAKS AND RECEIVE REGULAR PREVENTION MAINTENANCE TO REDUCE THE CHANCE OF LEAKAGE.
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Row #	Revision Issue Description	Row #	Revision Issue Description
1	IS THE BUFFER BEING ENCLOSED ON?	1	REASON FOR BUFFER ENCLOSEMENT
2	50 FT	2	PROPOSED TRAIL ALIGNMENT INTENDED TO ENCOURAGE APPRECIATION OF NATURAL RESOURCES. NEEDED FOR BOARDWALK CONSTRUCTION.
3	10-001/2-00 LAKE ANN	3	PROPOSED TRAIL ALIGNMENT INTENDED TO ENCOURAGE APPRECIATION OF NATURAL RESOURCES. NEEDED FOR BOARDWALK CONSTRUCTION.

SEH Project # H03171684
 Drawn By #
 Designed By #
 Checked By #

Revision Issue Description

Row #

Date

Row #

Date

Revision Issue Description

90% PRELIMINARY

SEH

HERBERT CERTIFY THAT THIS PLAN WAS PREPARED BY ME OR UNDER MY DIRECT SUPERVISION AND THAT I AM A LICENSED PROFESSIONAL ENGINEER IN THE STATE OF MINNESOTA.

DATE: 01-12-2024
 LICENSE NO: 44581

LAKE ANN PRESERVE IMPROVEMENTS

STORM WATER POLLUTION PREVENTION PLAN

CHANHASSEN, MN

16 of 55

BOX	QUESTION	CRITERIA OR CHECK-BOX
STEP I - ASSESS THE SITE AND PROPOSED LOCATION OF THE BMP		
1	IS THE SITE CONTAMINATED OR DOES IT HAVE A HISTORY OF SOIL OR GROUNDWATER CONTAMINATION AT LEVELS OF CONCERN? IF YES, PROCEED TO BOX 2; IF NO, PROCEED TO BOX 3.	NO
2	IF ANSWER TO BOX 1 IS YES, IS THE CONTAMINATED SOIL OR GROUNDWATER BEEN REMEDIATED TO ACCEPTABLE LEVELS?	N/A
3	FOR BOXES 4 THROUGH 12, CHECK EACH BOX IN WHICH THE ITEM OCCURS ON THE SITE WITH THE FOLLOWING:	
4	UNDERGROUND STORAGE TANKS VENT(S) OR FILL PORT(S)	
5	MONITORING WELLS	
6	SOIL PILES(S) COVERED WITH PLASTIC SHEETING OR TARPS(S)	
7	STAINING OF SOIL(S) AND/OR DEAD VEGETATION	
8	UNUSUAL ODORS	
9	MISMANAGED DRUM(S) OR CHEMICAL CONTAINERS	
10	EXCAVATION(S) THAT IS/ARE NOT BACKFILLED WITH CLEAN MATERIAL	
11	PRESENCE OF DEBRIS THAT MAY INDICATE PRESENCE OF STRUCTURE(S) OR ACTIVITY(IES) THAT COULD RESULT IN CONTAMINATION	
12	SITE IS A CONFIRMED STORMWATER HOTSPOT	
13	ARE THERE ANY POTENTIAL SOURCES IDENTIFIED (CHECKED) IN BOXES 4 THROUGH 12? IF YES, PROCEED TO BOX 14; IF NO, PROCEED TO BOX 15.	
14	FOR ALL POTENTIAL SOURCES IDENTIFIED (CHECKED) IN BOXES 5 THROUGH 13, CAN ADEQUATE SEPARATION BE ACHIEVED? IF YES, PROCEED TO BOX 16.	
STEP II - ASSESSING ADJACENT PROPERTIES		
15	FOR BOXES 16 THROUGH 26, CHECK EACH BOX IN WHICH THE ITEM OCCURS WITHIN THE INFLUENCE ZONE OF THE SITE PROPERTY. SEE INFLUENCE ZONE WORKSHEET.	
16	KNOWN GROUNDWATER CONTAMINATION ON ADJACENT PROPERTY	
17	UNDERGROUND STORAGE TANK VENTS OR FILL PORTS	
18	MONITORING WELLS	
19	SOIL PILES COVERED WITH PLASTIC SHEETING OR TARPS	
20	STAINING OF SOIL(S) AND/OR DEAD VEGETATION	
21	UNUSUAL ODORS	
22	MISMANAGED DRUMS OR CHEMICAL CONTAINERS	
23	EXCAVATIONS THAT ARE NOT BACKFILLED WITH CLEAN MATERIAL	
24	PRESENCE OF DEBRIS THAT MAY INDICATE PRESENCE OF STRUCTURES OR ACTIVITY(IES) THAT COULD RESULT IN CONTAMINATION	
25	SITE IS A CONFIRMED STORMWATER HOTSPOT	
26	ARE ANY POTENTIAL SOURCES IDENTIFIED IN BOXES 16 THROUGH 25? IF YES, PROCEED TO BOX 27.	NO
27	FOR BOXES 26 THROUGH 27, ARE THERE ANY POTENTIAL SOURCES IDENTIFIED IN BOXES 16 THROUGH 25, CAN ADEQUATE SEPARATION BE ACHIEVED? IF NO, PROCEED TO BOX 28.	
28	IF BOX 28 IS NO, STOP. THERE IS SUFFICIENT INFORMATION TO SUGGEST CONTAMINANTS MAY BE MOBILIZED BY INFILTRATION. FOR CONSTRUCTION STORMWATER PERMITS, INFILTRATION IS PROHIBITED WHEN THE INFILTRATION SYSTEM WILL BE CONSTRUCTED IN AREAS WHERE HIGH LEVELS OF CONTAMINANTS IN SOIL OR GROUNDWATER WILL BE MOBILIZED BY INFILTRATING STORMWATER.	

PERMIT TERMINATION CONDITIONS
 THE CONTRACTOR IS RESPONSIBLE FOR ENSURING FINAL STABILIZATION OF THE ENTIRE SITE. PERMIT TERMINATION CONDITIONS INCLUDE BUT ARE NOT LIMITED TO THE FOLLOWING:

- ALL SOIL DISTURBING ACTIVITIES HAVE BEEN COMPLETED.
- ALL PERMANENT STORMWATER MANAGEMENT SYSTEMS ARE CONSTRUCTED AND ARE OPERATING AS DESIGNED.
- ALL DRAINAGE DITCHES, PONDS, AND ALL STORM WATER CONVEYANCE SYSTEMS HAVE BEEN CLEARED OF SEDIMENT AND STABILIZED WITH PERMANENT COVER TO PRECLUDE EROSION.
- ALL TEMPORARY SYNTHETIC BMPs HAVE BEEN REMOVED AND PROPERLY DISPOSED OF.

THIS PERMIT COVERS ONGOING PROJECTS COVERED UNDER ANY PREVIOUS CONSTRUCTION STORMWATER PERMIT THAT ARE NOT COMPLETE ON THE ISSUANCE DATE OF THIS PERMIT. PERMITTEES MUST EITHER REMAIN IN COMPLIANCE WITH THE PERMIT OR COMPLY WITH THIS PERMIT, INCLUDING UPDATING THE STORMWATER POLLUTION PREVENTION PLAN (SWPPP), WITHIN THE 18-MONTH PERIOD. PERMITTEES OF PREVIOUSLY PERMITTED PROJECTS ARE NOT REQUIRED TO INCORPORATE ANY ADDITIONAL REQUIREMENTS REGARDING THE PERMANENT STORMWATER TREATMENT SYSTEM INCLUDED IN THIS REISSUED PERMIT.

COVERAGE FOR PROJECTS THAT EXTEND BEYOND THE EXPIRATION DATE OF THIS PERMIT REMAINS EFFECTIVE FOR A GRACE PERIOD OF 18 MONTHS COVERING PROJECT COMPLETION AND NOTICE OF TERMINATION (NOT PERMITTER'S RESPONSIBILITY). PERMITTEES OF PREVIOUSLY PERMITTED PROJECTS MUST COMPLY WITH THE REQUIREMENTS OF THE NEXT PERMIT INCLUDING UPDATING THE SWPPP. PERMITTEES ARE NOT REQUIRED TO FOLLOW CHANGES TO THE PERMANENT STORMWATER TREATMENT SECTION OF THE NEXT PERMIT.

WHEN SUBMITTING THE NOT PERMITTED MUST INCLUDE EITHER GROUND OR AERIAL PHOTOGRAPHS SHOWING THE DISPOSITION OF THE SITE. FOR THE CONDITIONS PORTFOLIO MUST BE SUBMITTED ANNUALLY SIMILAR TO THESE PHOTOGRAPHS. PHOTOGRAPHS MUST BE CLEAR AND IN FOCUS AND MUST INCLUDE THE DATE THE PHOTO WAS TAKEN. (MNN R. 7090)

LOCATION MAP



Revision Issue Description
 Row #
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SEH Project HIGS171654

Drawn By
 Designed By
 Checked By

Revision Issue Description

Row #

Date

90% PRELIMINARY

Revision Issue Description

Row #



HEREBY CERTIFY THAT THIS PLAN WAS PREPARED BY ME OR UNDER MY DIRECT SUPERVISION AND THAT I AM A LICENSED PROFESSIONAL ENGINEER UNDER THE BOARD OF ENGINEERS OF THE STATE OF MINNESOTA.
 Signature
 DATE 01-12-2024 LICENSE NO. 44591

LAKE ANN PRESERVE IMPROVEMENTS
 CHANHASSEN, MN

STORM WATER POLLUTION
 PREVENTION PLAN



BITUMINOUS TRAIL 1

Station	Existing Ground Elevation	Proposed Centerline Profile
985		
990		
975		
970		
965		
960		
955		
950		
948		

SEH Project: H03171854
 Drawn By: [Blank]
 Designed By: [Blank]
 Checked By: [Blank]

Revision Issue # Description
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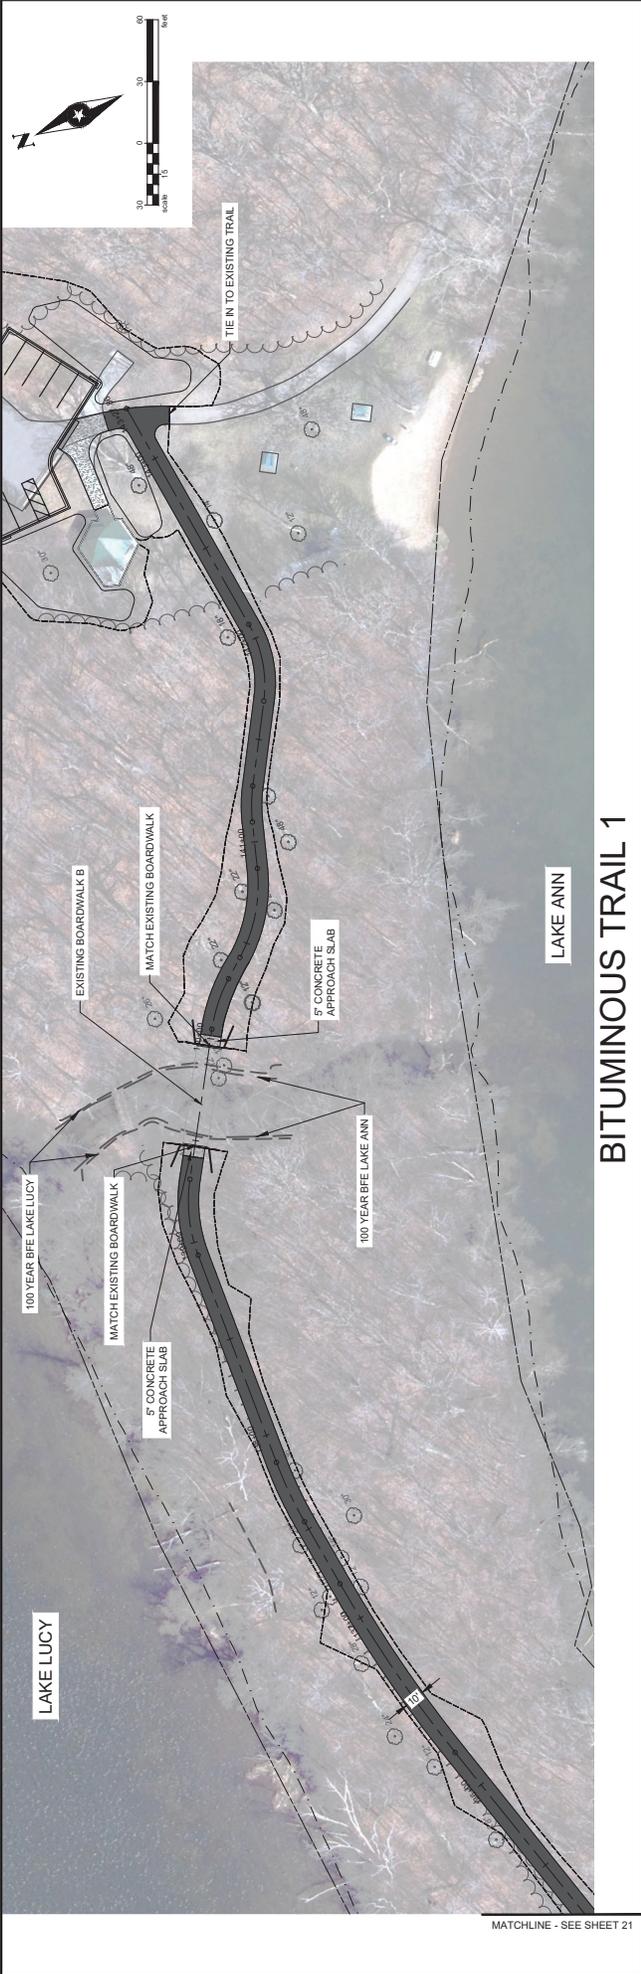
90% PRELIMINARY

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LAKE ANN PRESERVE IMPROVEMENTS
 CHANHASSEN, MN


CONSTRUCTION PLAN AND PROFILE
 21 of 55

SHEET 1718224 2 12 PM (Revised) PLOT: 2/26/2024 12:11 PM X:\JH\H03171854\Final\dwg\171824P-BK-1.dwg
 I HEREBY CERTIFY THAT THIS PLAN WAS PREPARED BY ME OR UNDER MY DIRECT SUPERVISION AND THAT I AM A LICENSED PROFESSIONAL ENGINEER UNDER THE LAWS OF THE STATE OF MINNESOTA.
 JENNIFER LORENZO, P.E.
 DATE: 01-17-2024 LICENSE NO: 44581




BITUMINOUS TRAIL 1

LAKE ANN

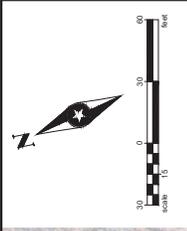

MATCHLINE - SEE SHEET 21

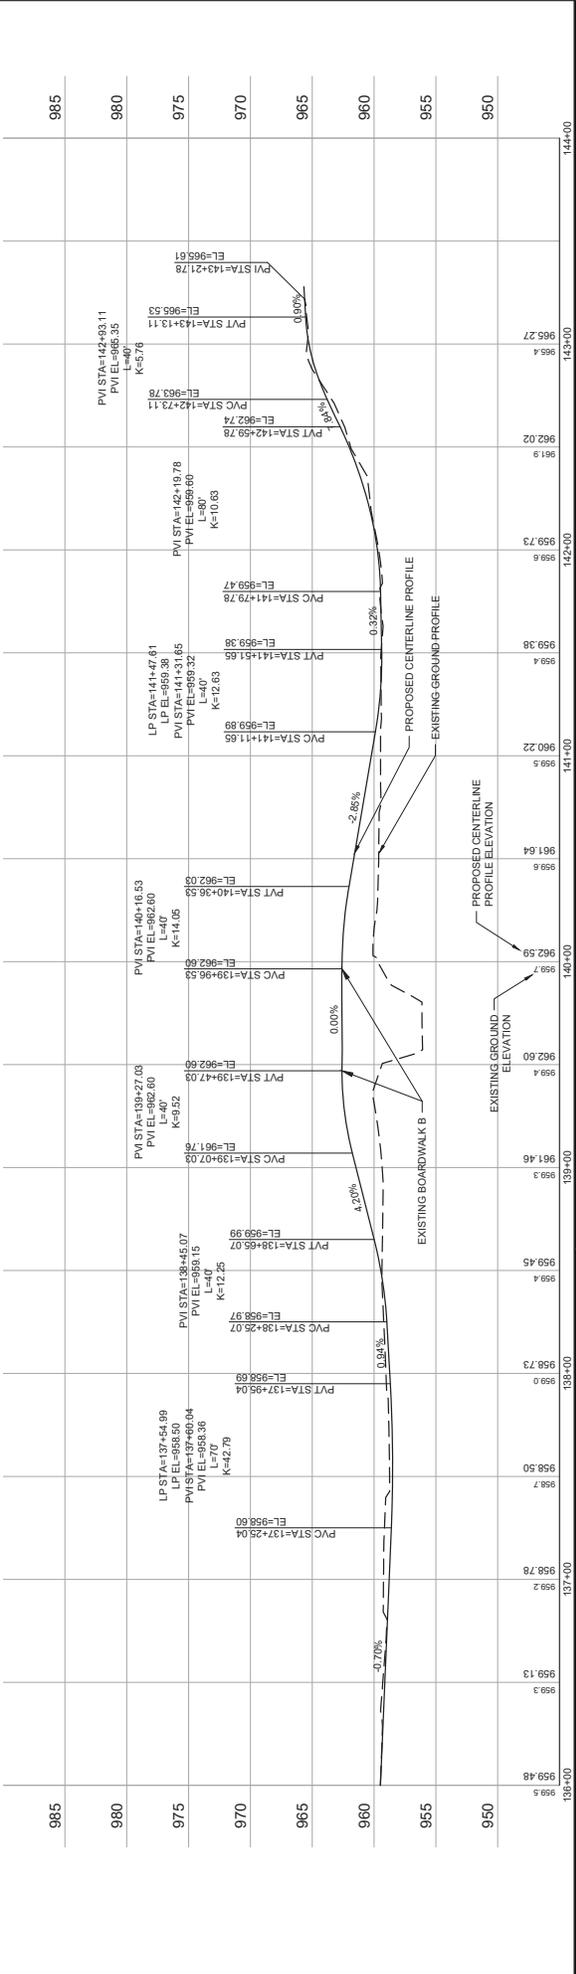

Rev #	Date	Revision Issue Description	Row #	Date	Revision Issue Description	Row #
1			985			985
2			980			980
3			975			975
4			970			970
5			965			965
6			960			960
7			955			955
8			950			950

SEH Project: H0517684

Drawn By: _____

Designed By: _____

Checked By: _____

90% PRELIMINARY

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LAKE ANN PRESERVE IMPROVEMENTS

CHANHASSEN, MN

DATE: 01.12.2024


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CONSTRUCTION PLAN AND PROFILE

22 of 55



BITUMINOUS TRAIL 2

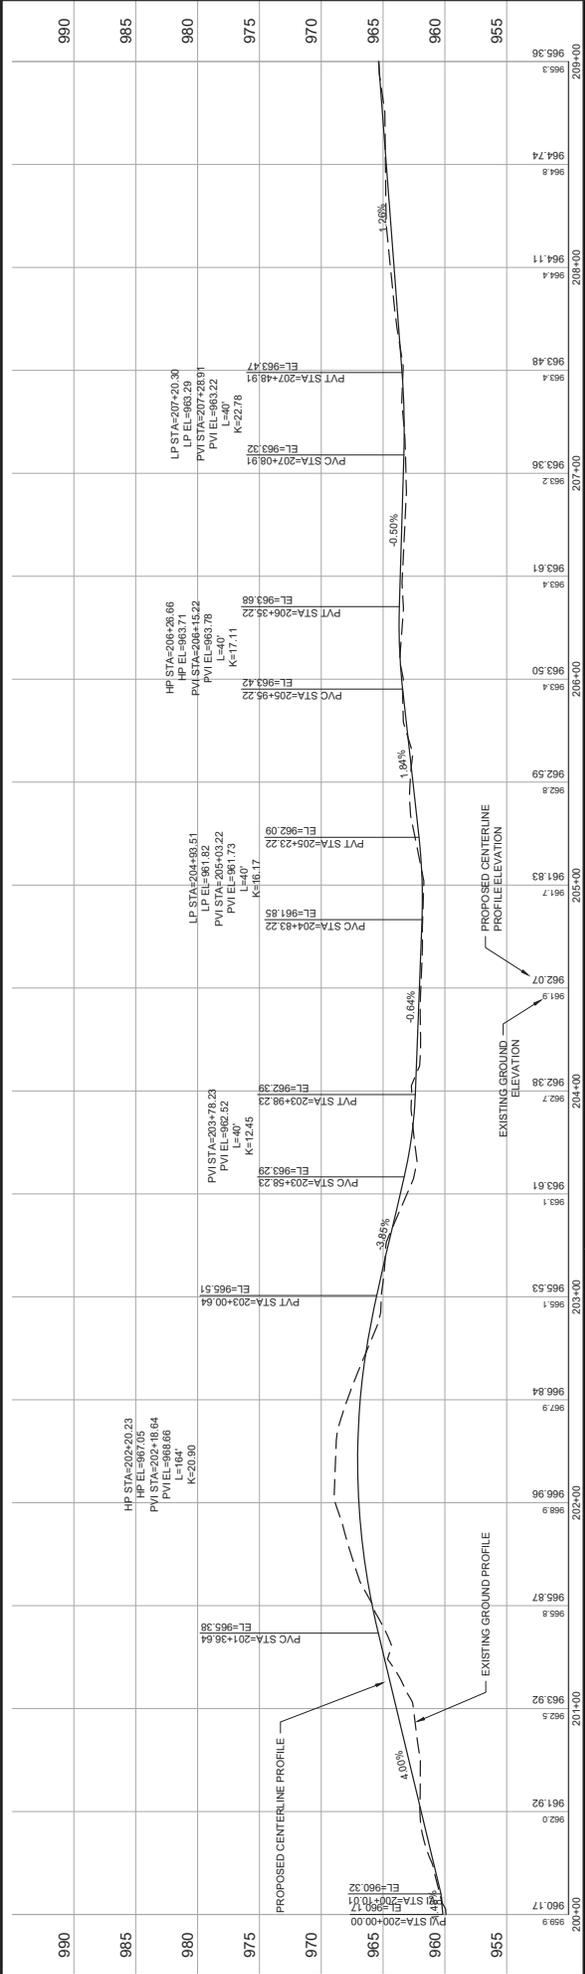

SEH Project: H0517684
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Revision Issue: [Blank]
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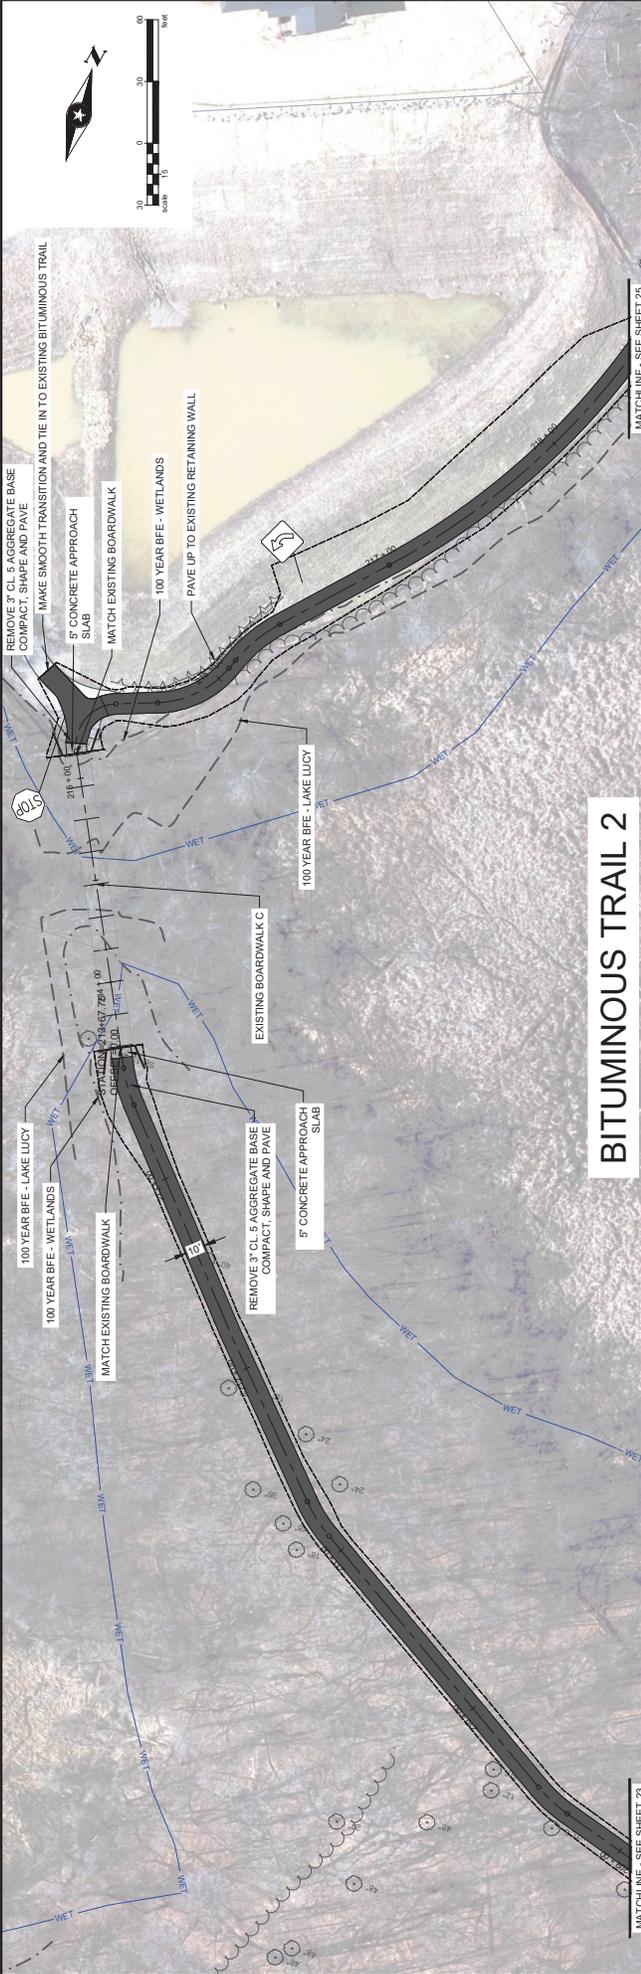
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SEH
 SEANERIC CORPORATION, INC.
 401 E. 12th Street, Suite 200
 Lincoln, NE 68502
 Phone: (402) 441-2000
 Fax: (402) 441-2001
 Email: info@seh.com


CHANHASSEN, MN
 LICENSE NO. 44581

CONSTRUCTION PLAN AND PROFILE

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BITUMINOUS TRAIL 2



Station	Elevation	Profile Type
208+00	963.36	Existing Ground
208+00	963.36	Proposed Centerline
209+00	965.76	Existing Ground
209+00	965.76	Proposed Centerline
210+00	965.31	Existing Ground
210+00	965.31	Proposed Centerline
211+00	964.82	Existing Ground
211+00	964.82	Proposed Centerline
212+00	963.44	Existing Ground
212+00	963.44	Proposed Centerline
213+00	962.28	Existing Ground
213+00	962.28	Proposed Centerline
214+00	962.28	Existing Ground
214+00	962.28	Proposed Centerline
215+00	962.28	Existing Ground
215+00	962.28	Proposed Centerline
216+00	961.35	Existing Ground
216+00	961.35	Proposed Centerline
217+00	960.60	Existing Ground
217+00	960.60	Proposed Centerline
218+00	959.09	Existing Ground
218+00	959.09	Proposed Centerline

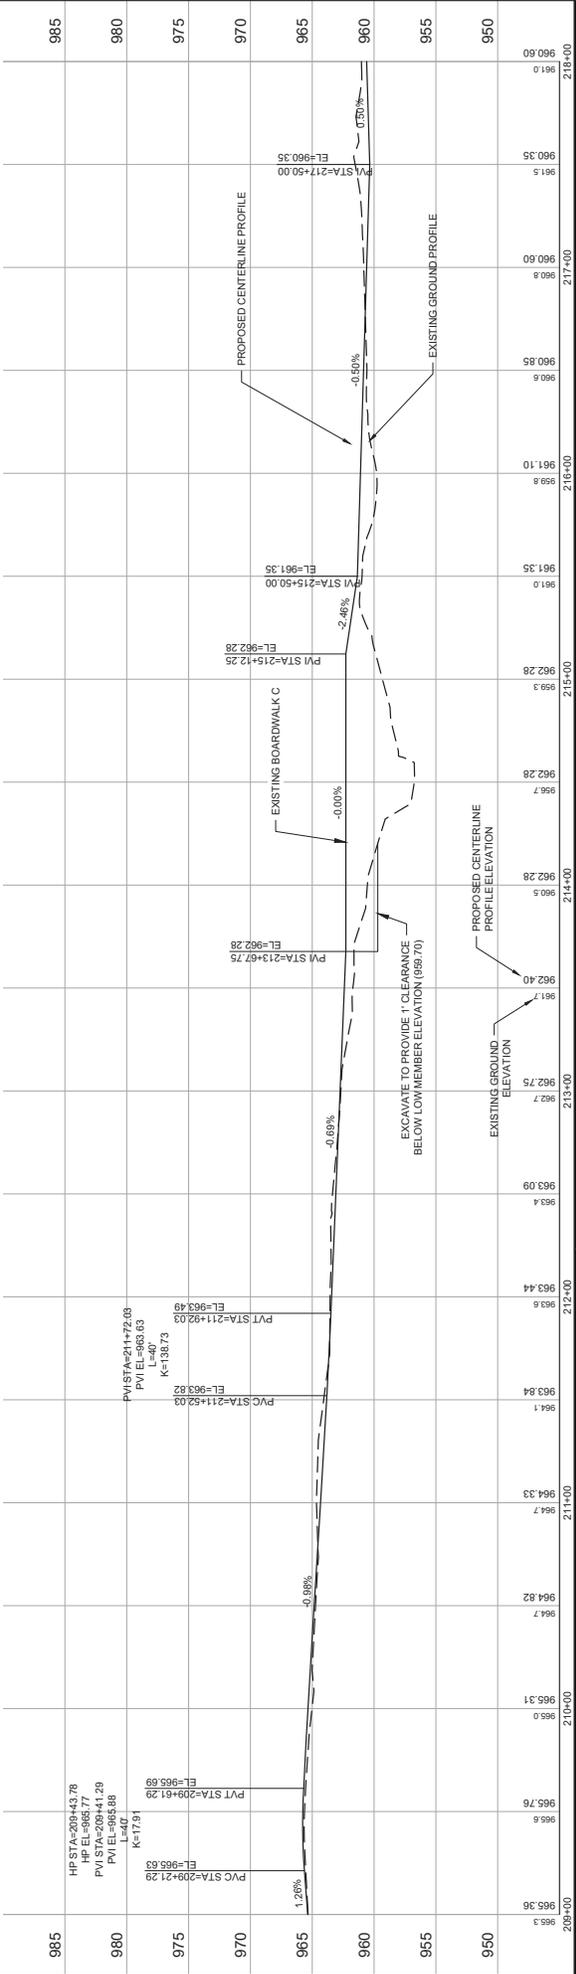90% PRELIMINARY

SEH

LAKE ANN PRESERVE IMPROVEMENTS
CHANHASSEN, MN


CONSTRUCTION PLAN AND PROFILE
24 of 55



NOTES:

- EXCAVATE EXISTING TRAIL AND BASE TO PROPOSED SUBGRADE, INCLUDING 1' ADDITIONAL WIDTH ON EACH SIDE. RECOMPACT SUBGRADE, INSTALL CLASS 5 AND BITUMINOUS PAVEMENT PER TYPICAL SECTION.

BITUMINOUS TRAIL 2

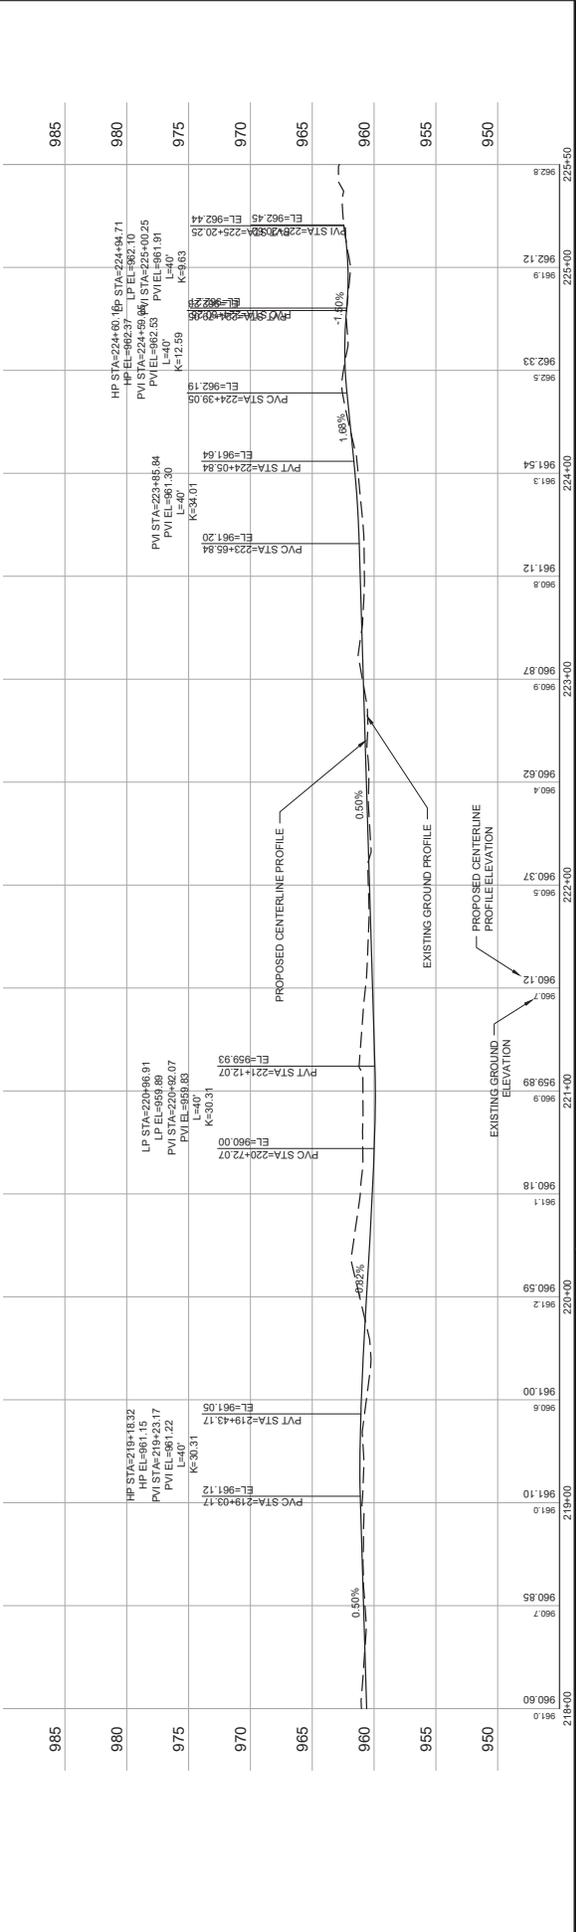

SEH Project	H0517684	Revision Issue	218+00	Revision Issue Description	218+00
Drawn By	-	Date	219+00	Row #	1
Designed By	-	Date	220+00	Row #	2
Checked By	-	Date	221+00	Row #	3
		Date	222+00	Row #	4
		Date	223+00	Row #	5
		Date	224+00	Row #	6
		Date	225+00	Row #	7

90% PRELIMINARY

SEH

I HEREBY CERTIFY THAT THIS PLAN WAS PREPARED BY ME OR UNDER MY DIRECT SUPERVISION AND THAT I AM A LICENSED PROFESSIONAL ENGINEER UNDER THE LAWS OF THE STATE OF MINNESOTA.

JENNIFER GUNDEL, P.E.
DATE: 01-17-2024 LICENSE NO: 44581

LAKE ANN PRESERVE IMPROVEMENTS
CHANHASSEN, MN

25
of 55


CONSTRUCTION PLAN AND PROFILE



BITUMINOUS TRAIL 2



SEH Project H0817684	Revision Issue Description	Rev #	Date	Rev #	Date	Rev #	Date
Drawn By -	90% PRELIMINARY	1					
Designed By -	SEH						
Checked By -	LAKE ANN PRESERVE IMPROVEMENTS						
	CHANHASSEN, MN						
	CONSTRUCTION PLAN						
		26					
		of 55					

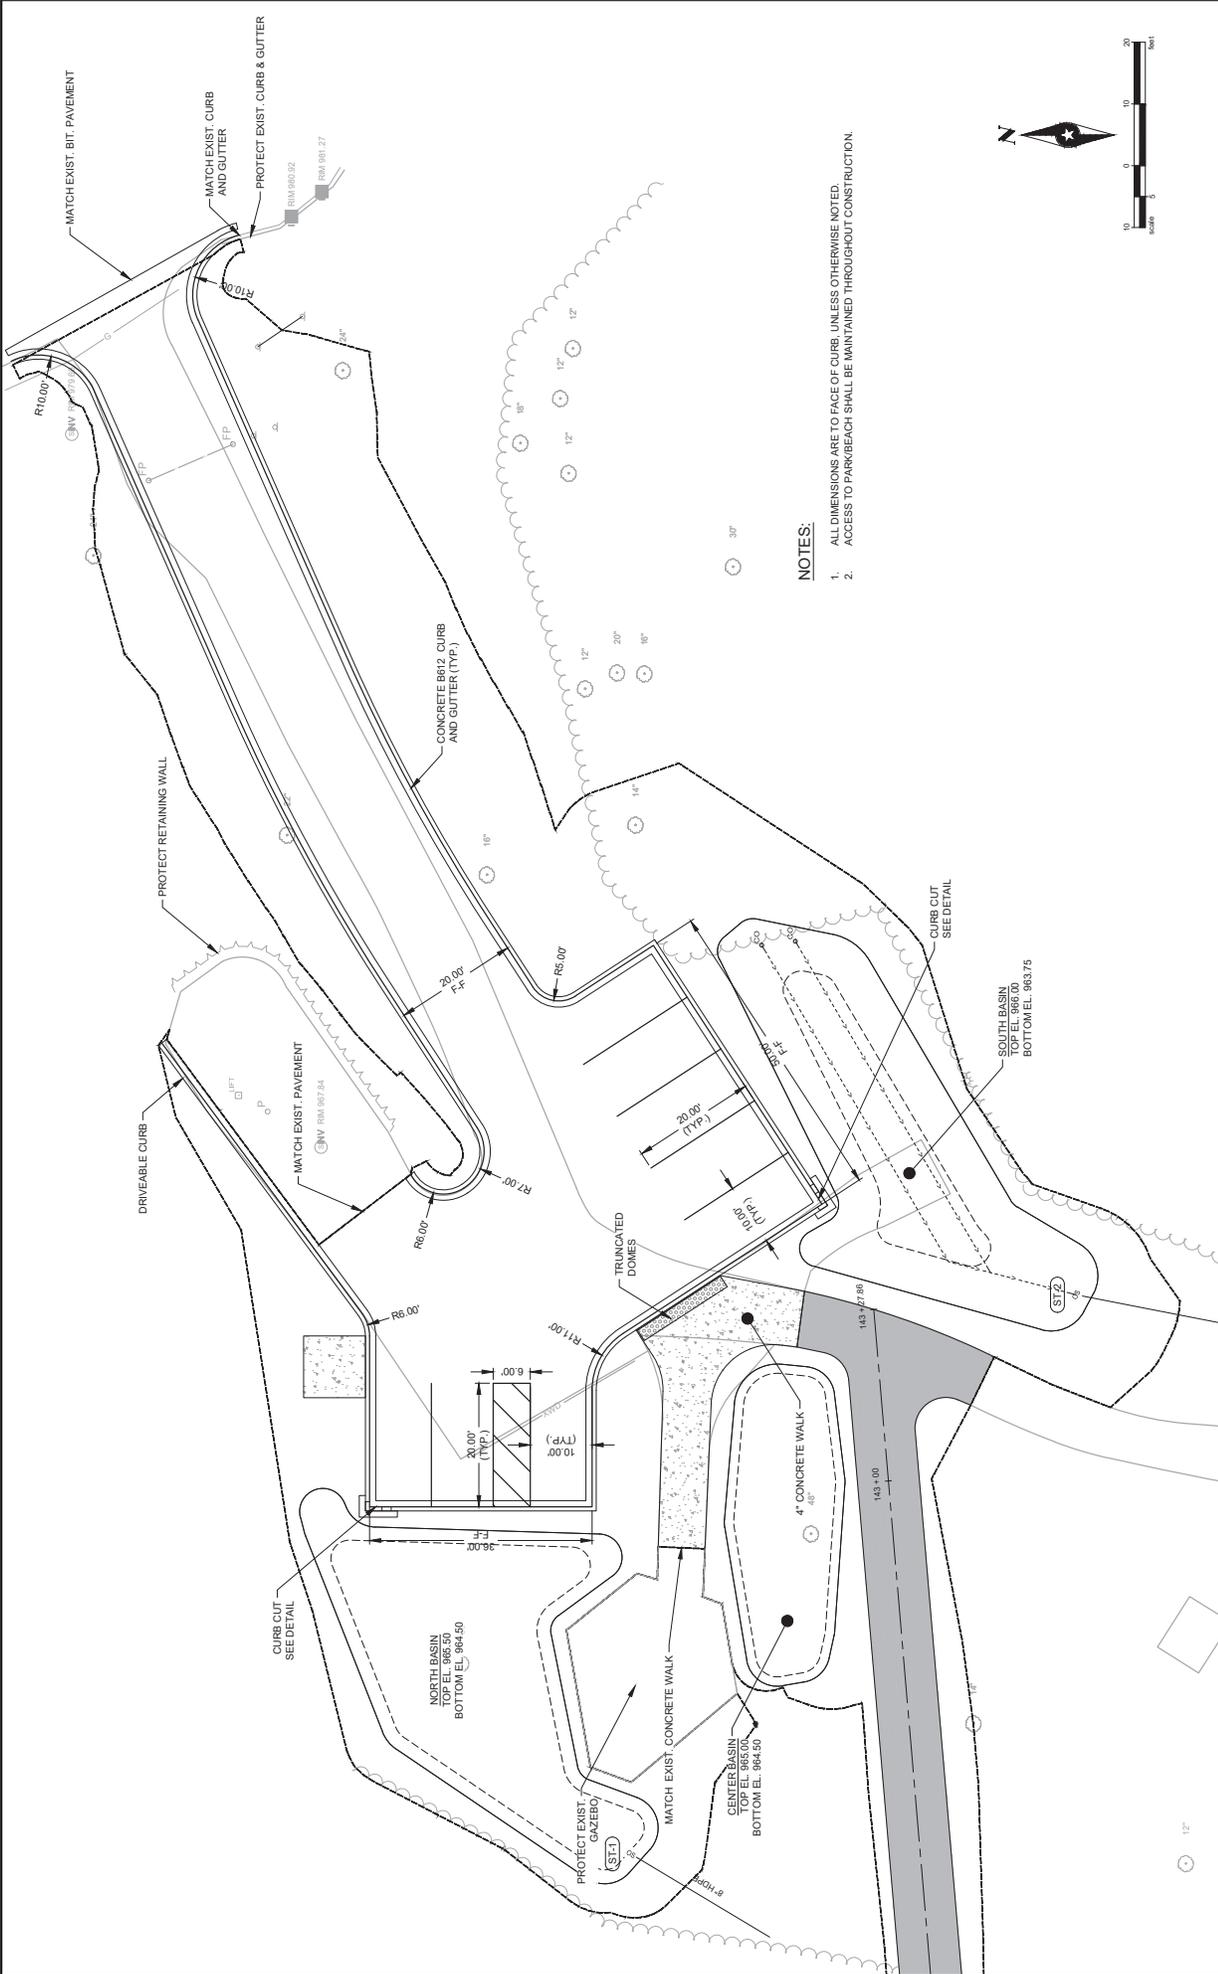

NOTES:
 1. ALL DIMENSIONS ARE TO FACE OF CURB, UNLESS OTHERWISE NOTED.
 2. ACCESS TO PARKBEACH SHALL BE MAINTAINED THROUGHOUT CONSTRUCTION.

HEREBY CERTIFY THAT THIS PLAN WAS PREPARED BY ME OR UNDER MY DIRECT SUPERVISION AND THAT I AM A FULLY LICENSED PROFESSIONAL ENGINEER UNDER THE BOARD OF ENGINEERS AND SURVEYORS OF THE STATE OF MINNESOTA.
 JENNIFER A. GIBSON, P.E.
 DATE: 01.12.2024 LICENSE NO. 44581




Revision Issue Description
 90% PRELIMINARY
 Row #
 Date

Revision Issue Description	Row #	Date
HOCS17684		
AJB		
##		

SEH Project: HOCS17684
 Drawn By: AJB
 Designed By: ##
 Checked By: ##




- NOTES:**
- STOCKPILE SANDY SURFACE SOILS SEPARATELY FOR USE ABOVE THE SUBDRAN.
 - INFILTRATION BASIN CONSTRUCTION: THE CONTRACTOR SHALL MAINTAIN PERIMETER SEDIMENT CONTROL MEASURES (I.E. SILT FENCE, SEDIMENT CONTROL LOGS) AROUND THE INFILTRATION BASIN DURING ALL PHASES OF CONSTRUCTION. THE INFILTRATION AREA MUST BE STAKED OFF AND MARKED TO KEEP ALL CONSTRUCTION TRAFFIC, EQUIPMENT AND MATERIAL STOCKPILES OUT OF THE PROPOSED INFILTRATION AREA.
 - COMPLETE STABILIZATION OF SURROUNDING AREAS DRAINING TO THE BASIN. ALL UPLAND DRAINAGE MUST BE DIVERTED TO PREVENT RUNOFF FROM ENTERING THE INFILTRATION BASIN WORK AREA.
 - NO EQUIPMENT SHALL BE DRIVEN IN THE AREA OF THE BASIN PRIOR TO ITS CONSTRUCTION, AND WHEN IT IS CONSTRUCTED ONLY LIGHT EARTH MOVING EQUIPMENT WITH TRACKS SHALL BE USED.
 - AFTER FINAL GRADING, THE BASIN'S FLOOR SHALL BE FILLED TO A DEPTH OF AT LEAST 6 INCHES TO PROVIDE A WELL-AERATED, POROUS SURFACE. SMearing OF THE SOIL IN THE BASIN SHALL BE AVOIDED AND IF SMearing DOES OCCUR IT SHALL BE CORRECTED BY RAKING OR RE-TILLING OF THE BASIN.
 - IMMEDIATELY FOLLOWING INFILTRATION BASIN CONSTRUCTION, THE ENTIRE BASIN SHALL BE SEEDED AND STABILIZED AS INDICATED IN THE PLANS. THE BASIN MUST BE FULLY STABILIZED PRIOR TO ANY UPSTREAM RUNOFF BEING DIRECT TO THE BASIN.
 - ALL NOT BE EXCAVATED WITHIN 3 FEET OF FINAL GRADE UNTIL THE CONTRIBUTING DRAINAGE AREAS HAS BEEN CONSTRUCTED AND FULLY STABILIZED. ANY ACCUMULATED SEDIMENT MUST BE REMOVED IN A MANNER THAT PREVENTS COMPACTION OF THE BOTTOM.

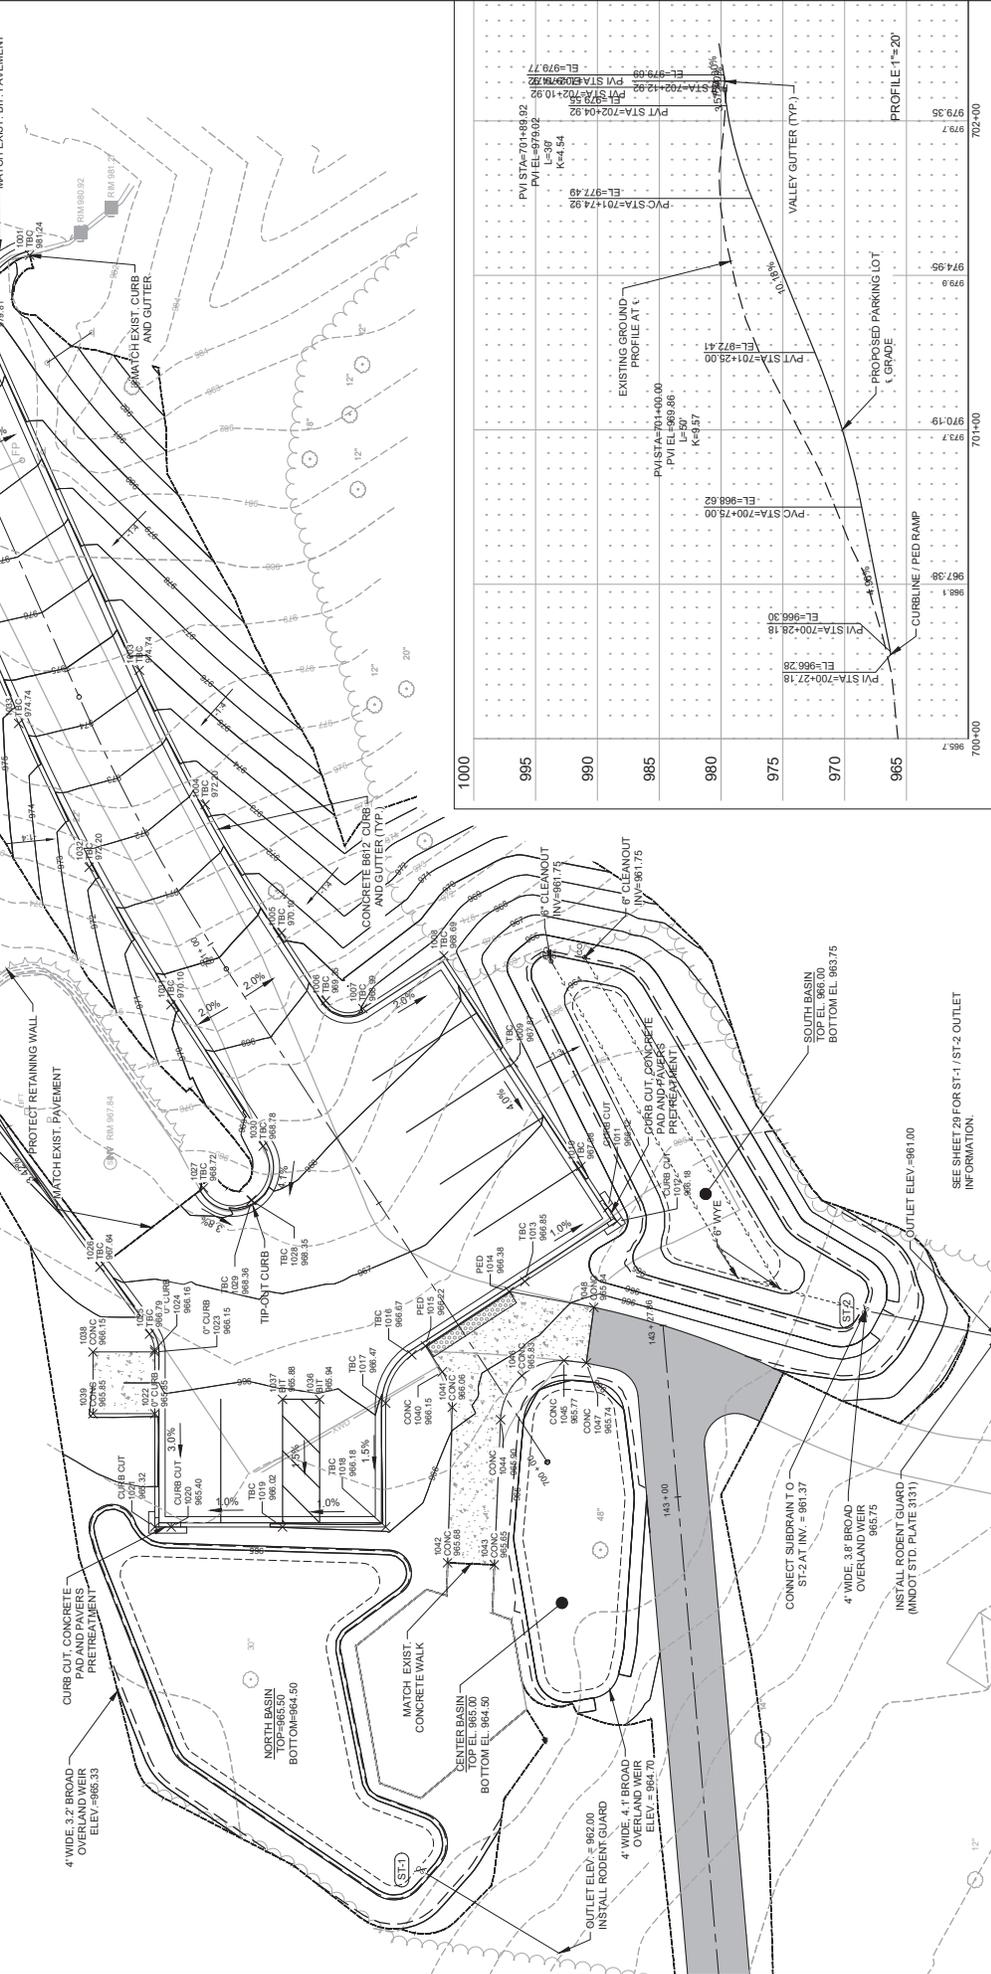


Station	Elevation	Notes
700+00	967.30	
700+10	967.30	
700+20	967.30	
700+30	967.30	
700+40	967.30	
700+50	967.30	
700+60	967.30	
700+70	967.30	
700+80	967.30	
700+90	967.30	
701+00	967.30	
701+10	967.30	
701+20	967.30	
701+30	967.30	
701+40	967.30	
701+50	967.30	
701+60	967.30	
701+70	967.30	
701+80	967.30	
701+90	967.30	
702+00	967.30	

Station	Elevation	Notes
PVI STA=70+00.00	EL=968.86	L=50'
PVI STA=70+25.00	EL=972.41	K=4.57
PVI STA=70+50.00	EL=975.96	
PVI STA=70+75.00	EL=979.51	
PVI STA=71+00.00	EL=983.06	
PVI STA=71+25.00	EL=986.61	
PVI STA=71+50.00	EL=990.16	
PVI STA=71+75.00	EL=993.71	
PVI STA=72+00.00	EL=997.26	
PVI STA=72+25.00	EL=1000.81	
PVI STA=72+50.00	EL=1004.36	
PVI STA=72+75.00	EL=1007.91	
PVI STA=73+00.00	EL=1011.46	
PVI STA=73+25.00	EL=1015.01	
PVI STA=73+50.00	EL=1018.56	
PVI STA=73+75.00	EL=1022.11	
PVI STA=74+00.00	EL=1025.66	
PVI STA=74+25.00	EL=1029.21	
PVI STA=74+50.00	EL=1032.76	
PVI STA=74+75.00	EL=1036.31	
PVI STA=75+00.00	EL=1039.86	
PVI STA=75+25.00	EL=1043.41	
PVI STA=75+50.00	EL=1046.96	
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PVI STA=99+50.00	EL=1387.76	
PVI STA=99+75.00	EL=1391.31	
PVI STA=100+00.00	EL=1394.86	

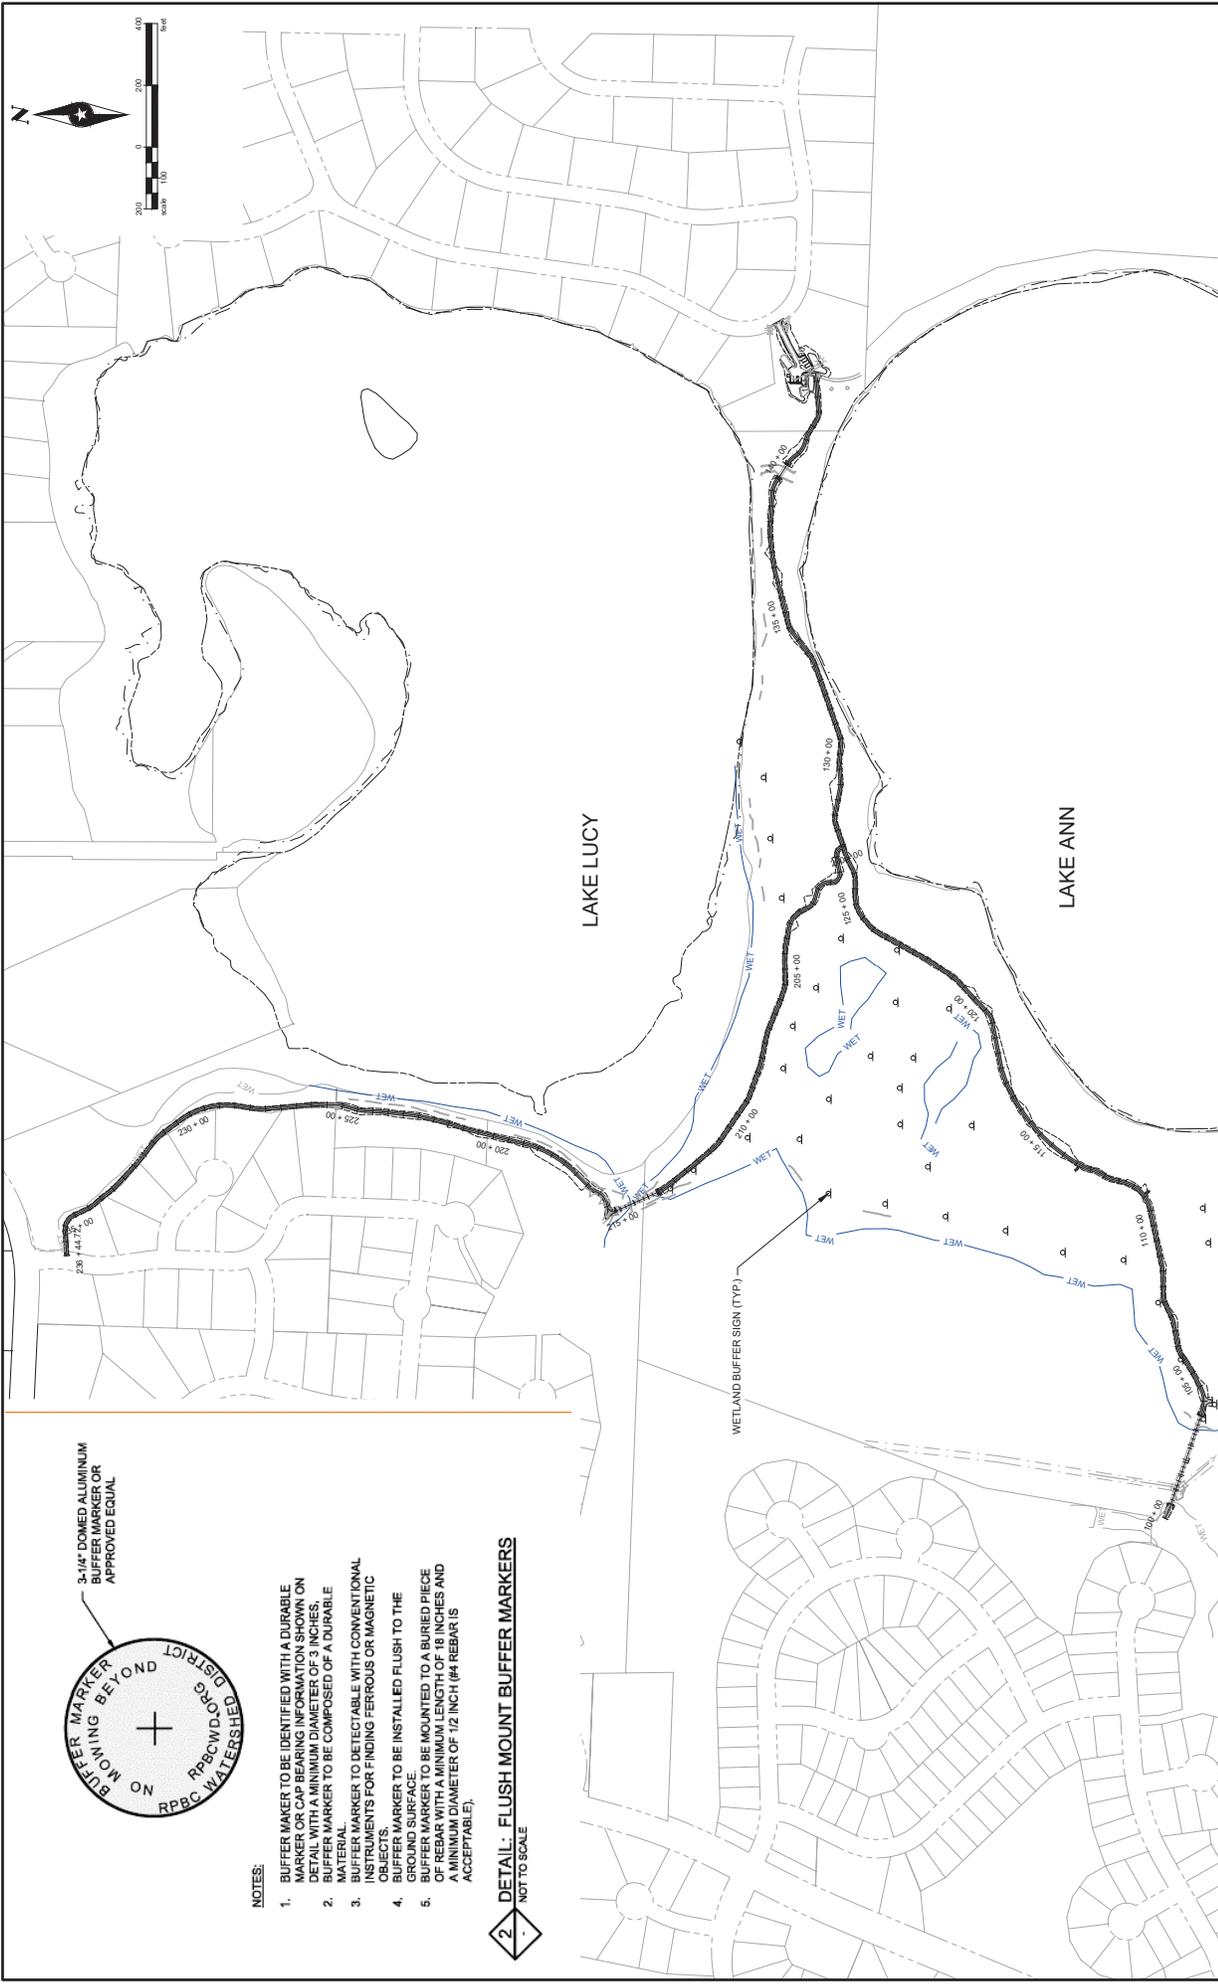

3-1/4" DOMED ALUMINUM
BUFFER MARKER OR
APPROVED EQUAL

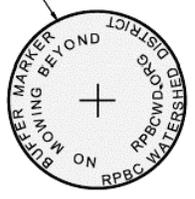

NOTES:

1. BUFFER MARKER TO BE IDENTIFIED WITH A DURABLE MARKER OR PERMANENT INFORMATION SHOWN ON DETAIL WITH A MINIMUM DIAMETER OF 3 INCHES.
2. BUFFER MARKER TO BE COMPOSED OF A DURABLE MATERIAL.
3. BUFFER MARKER TO BE DETECTABLE WITH CONVENTIONAL INSTRUMENTS FOR FINDING FERROUS OR MAGNETIC OBJECTS.
4. BUFFER MARKER TO BE INSTALLED FLUSH TO THE SURFACE.
5. BUFFER MARKER TO BE MOUNTED TO A BURIED PIECE OF REBAR WITH A MINIMUM LENGTH OF 18 INCHES AND A MINIMUM DIAMETER OF 1/2 INCH (#4 REBAR IS ACCEPTABLE).

2 DETAIL: FLUSH MOUNT BUFFER MARKERS
NOT TO SCALE

SEI Project	H2017184	Rev #		Revision Issue	
Drawn By		Date		Description	
Designed By					
Checked By					

90% PRELIMINARY





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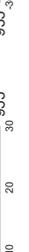
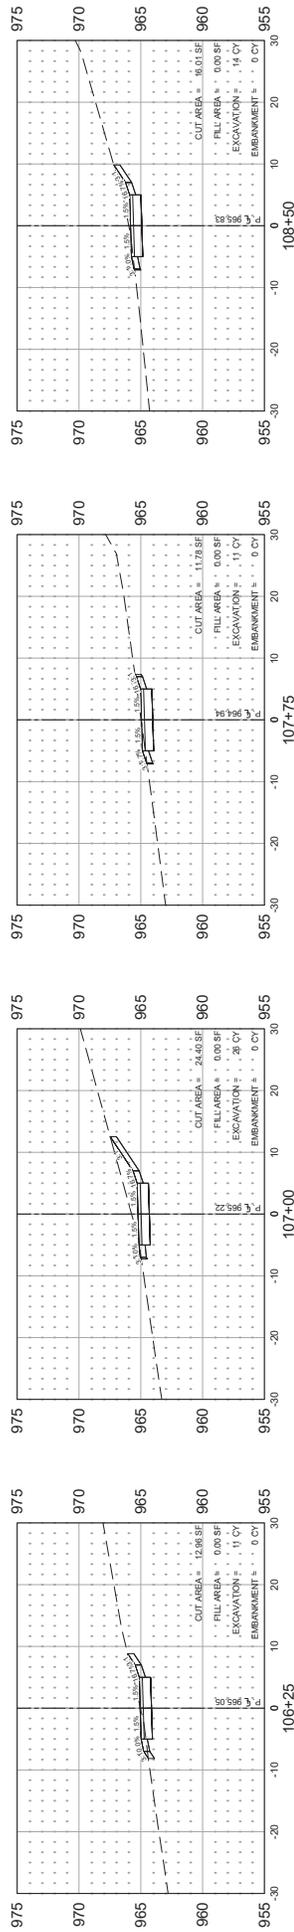
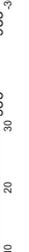
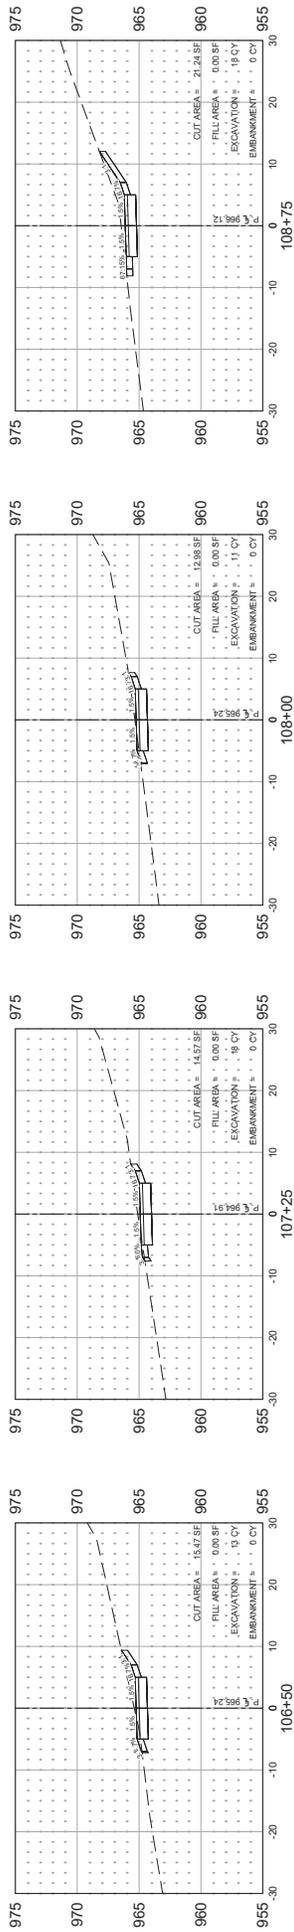
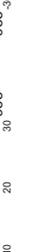
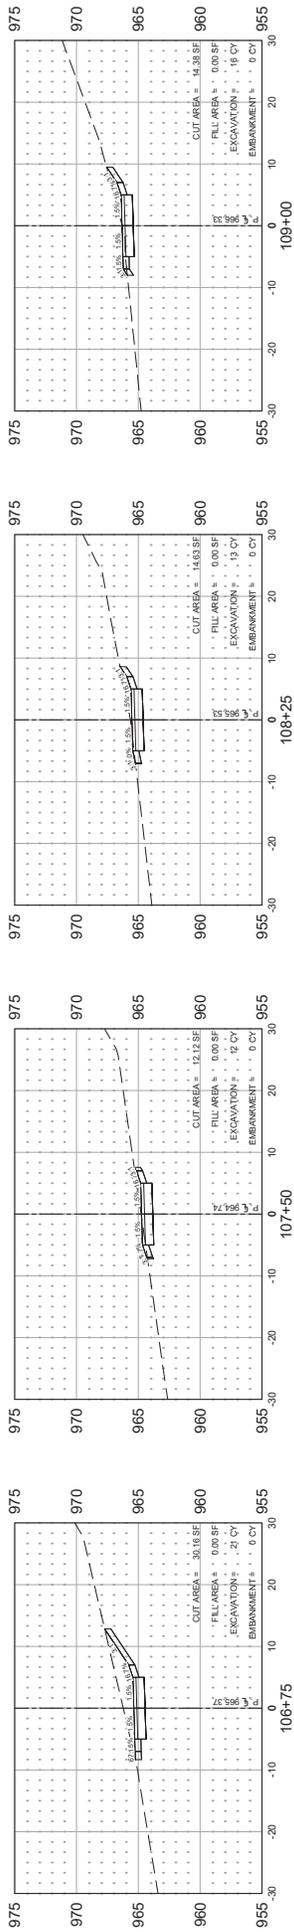

 JENNIFER DEBROSSE PE
 DATE: 04.11.2024 LICENSE NO. 44591













LAKE ANN PRESERVE IMPROVEMENTS
CHANHASSEN, MN


WETLAND BUFFER SIGNING

31 of 55




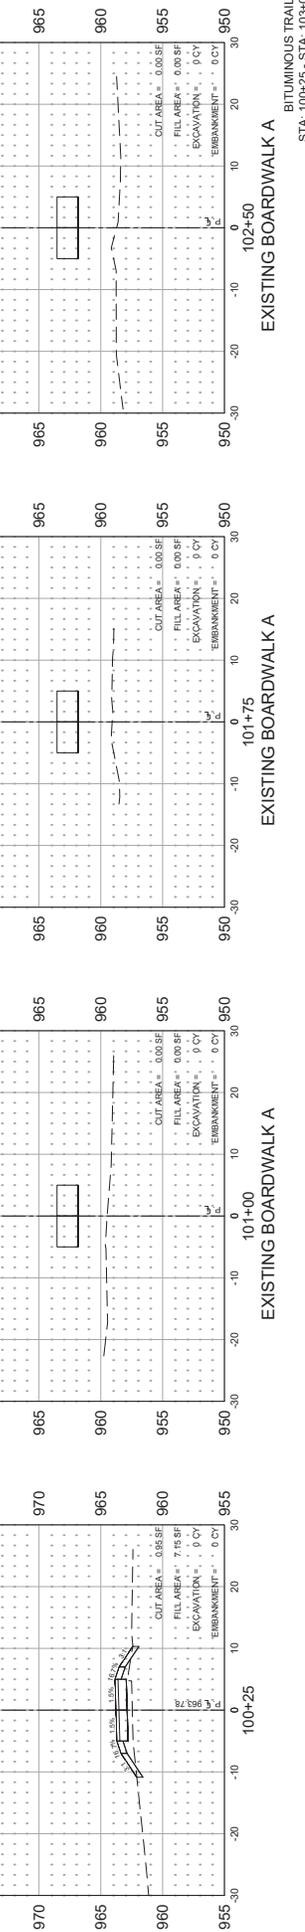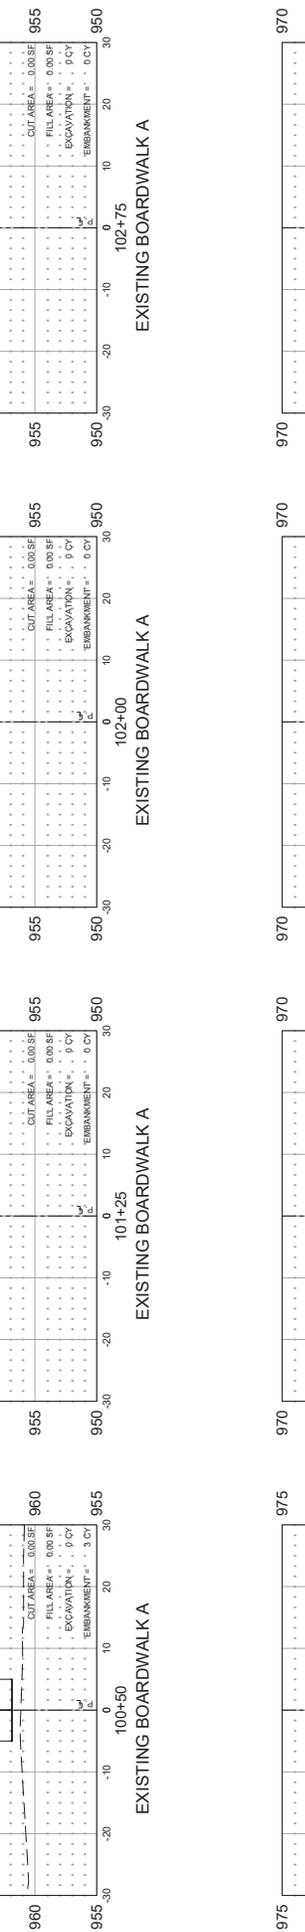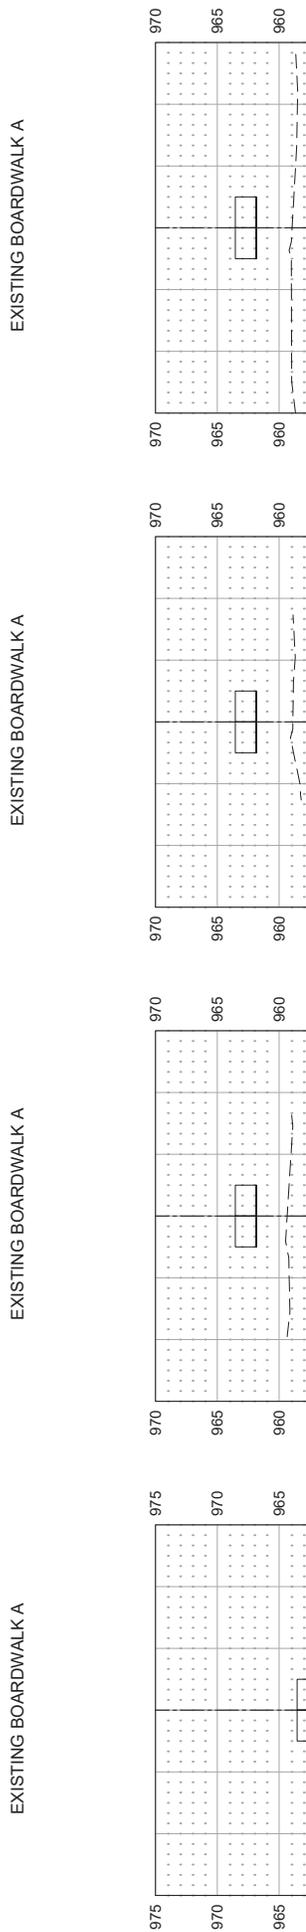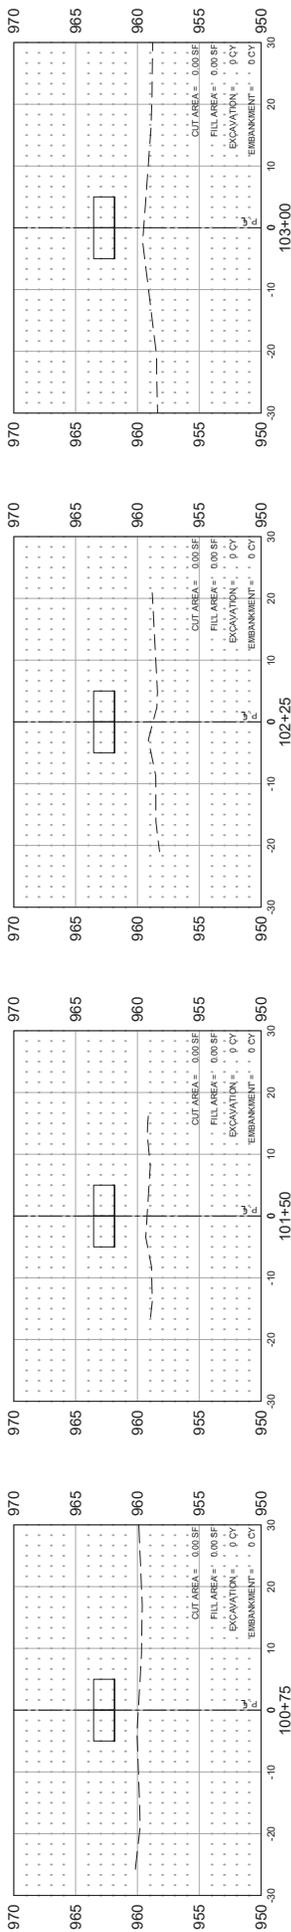

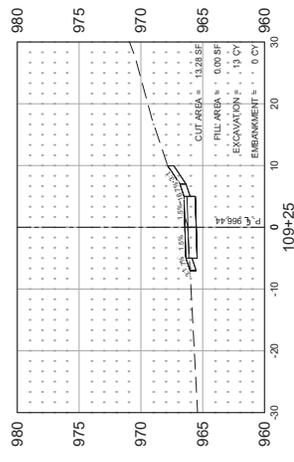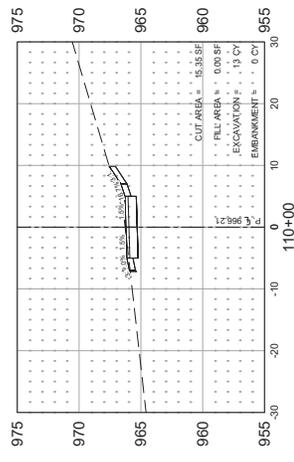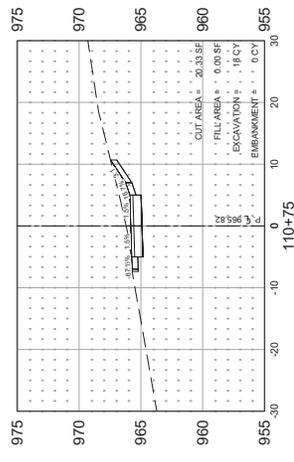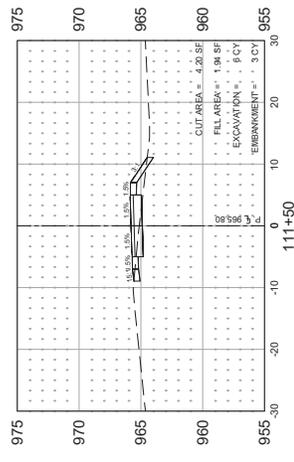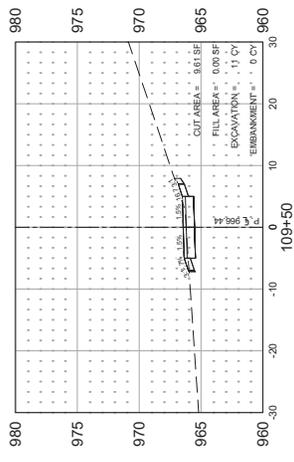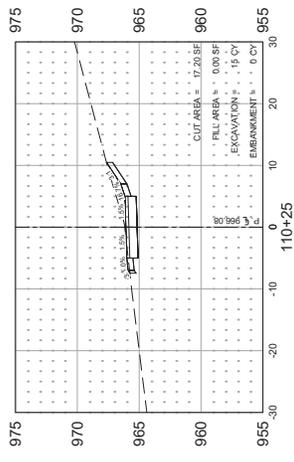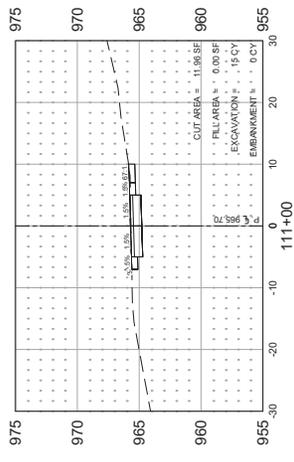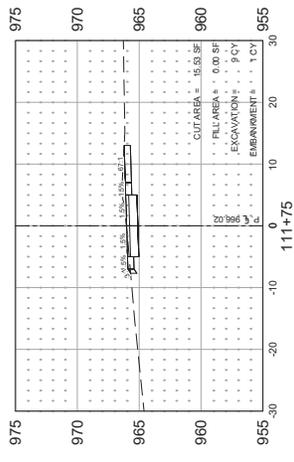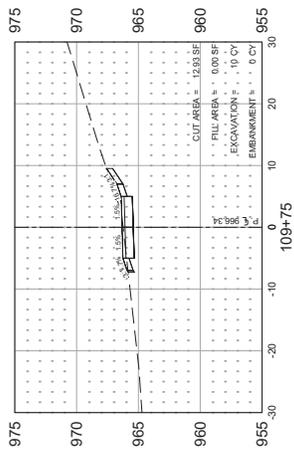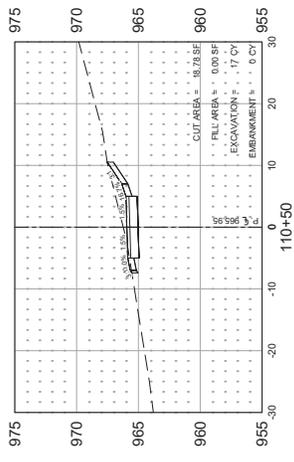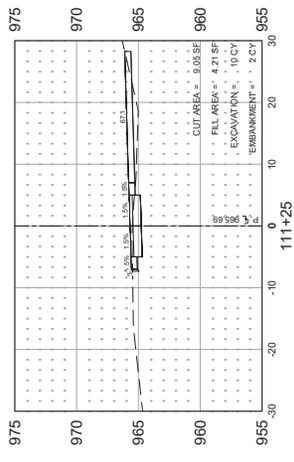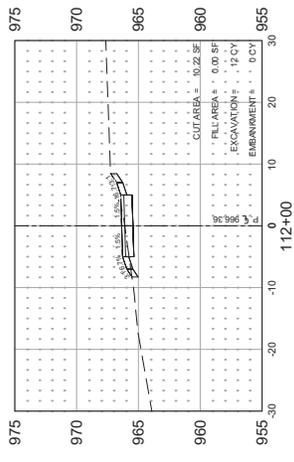


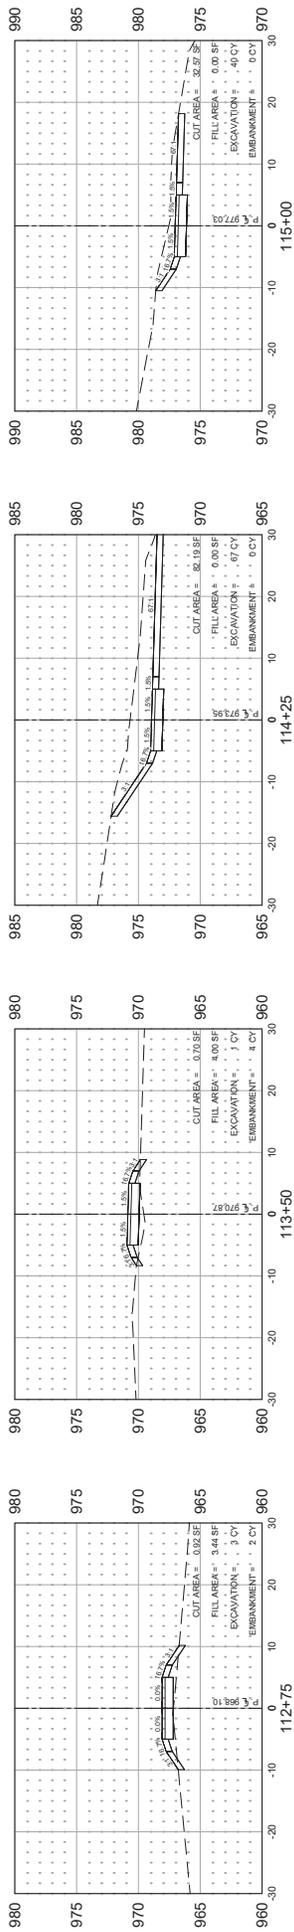


112+75

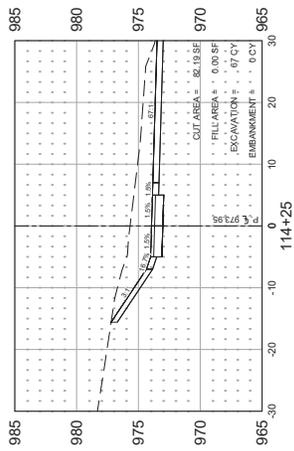


113+50

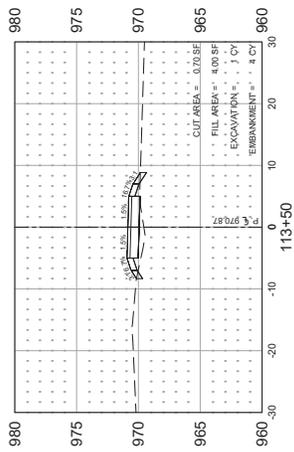


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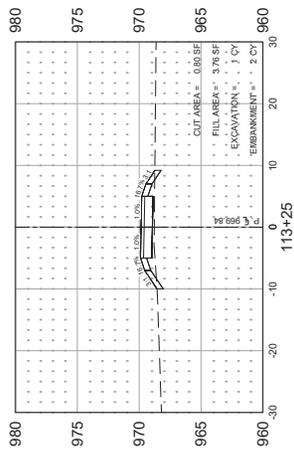
115+00

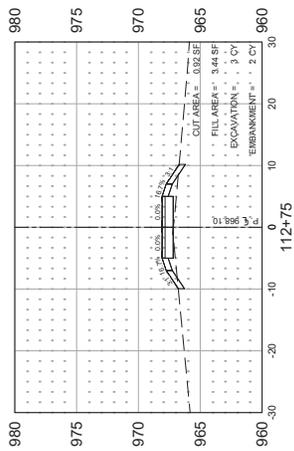


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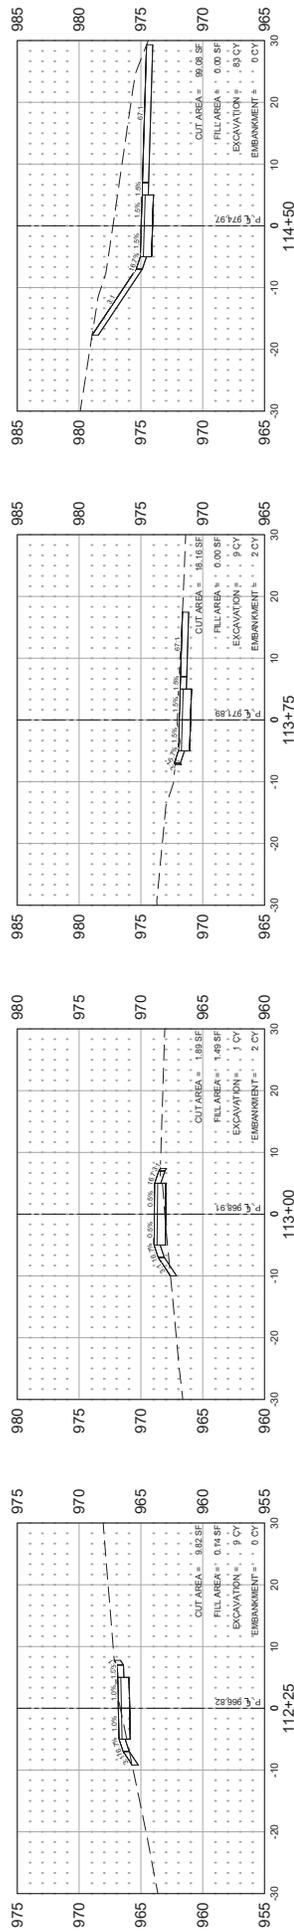
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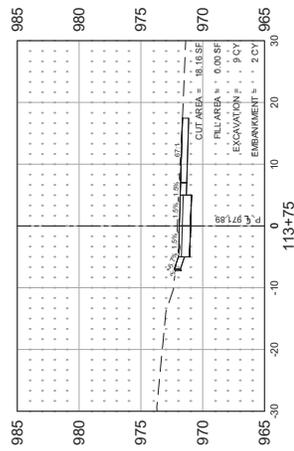
114+00

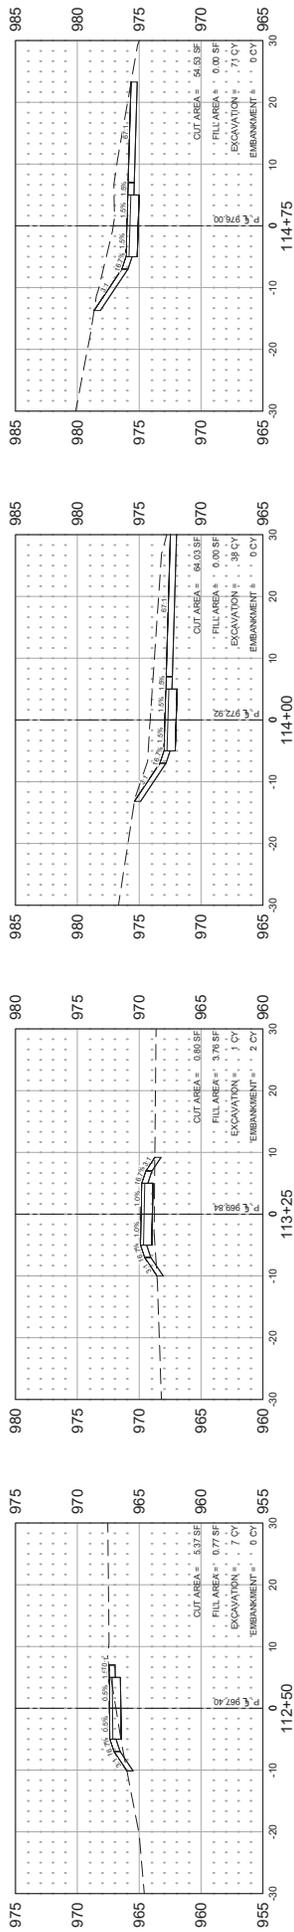


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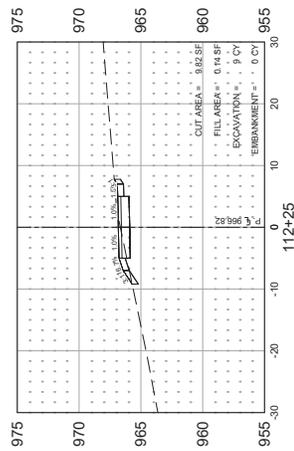
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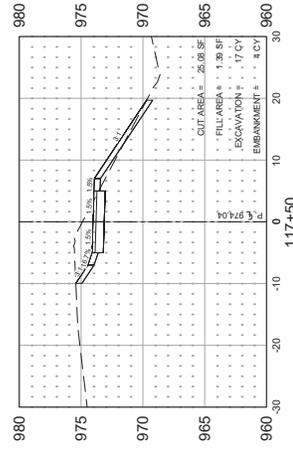
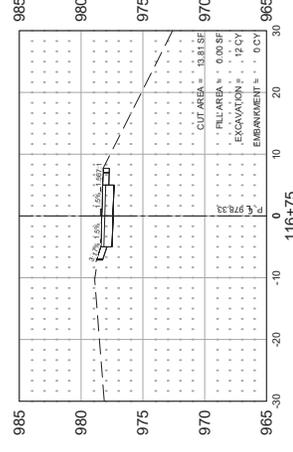
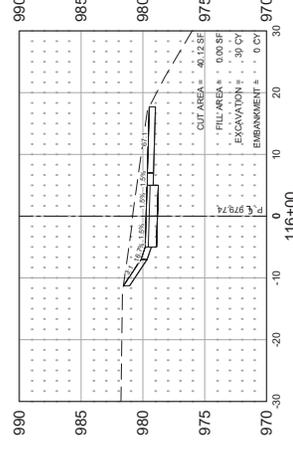
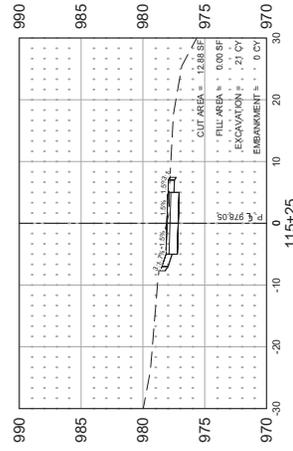
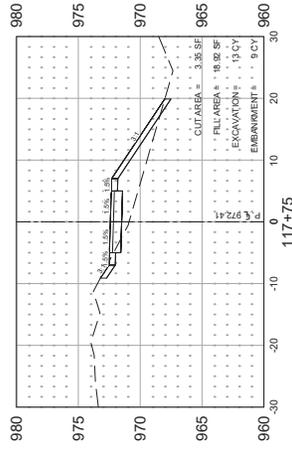
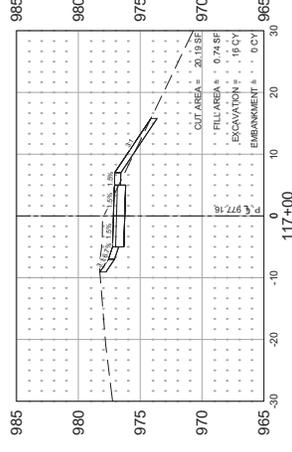
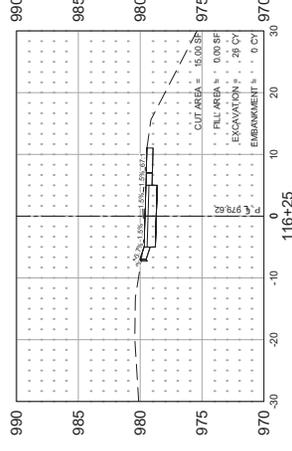
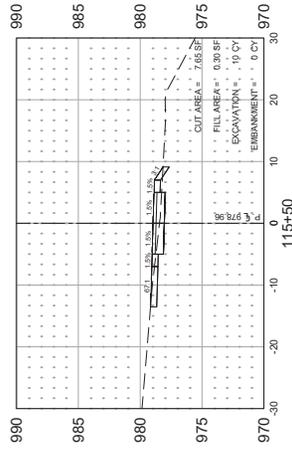
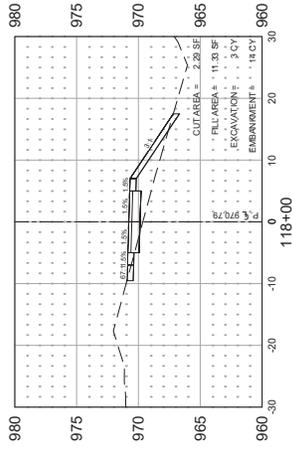
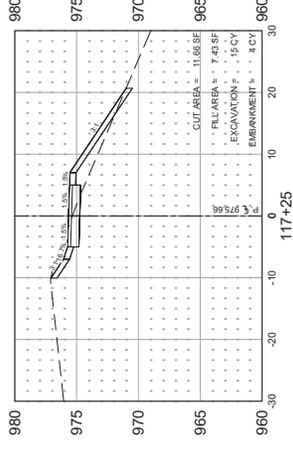
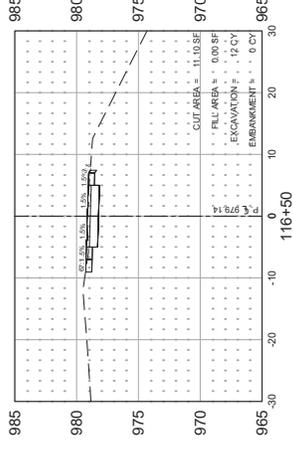
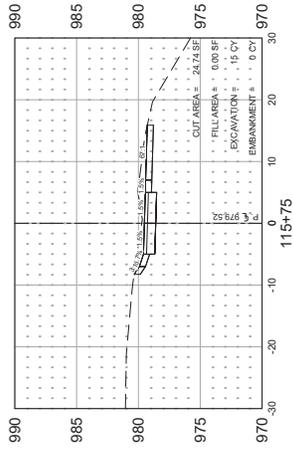
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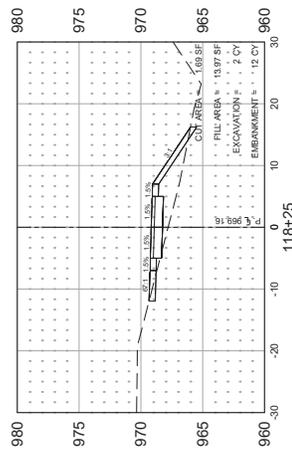
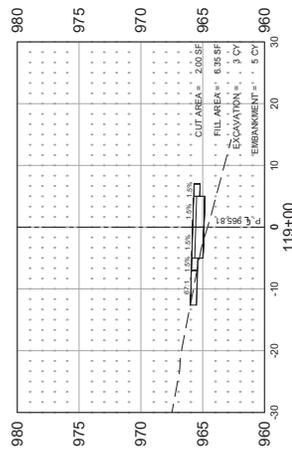
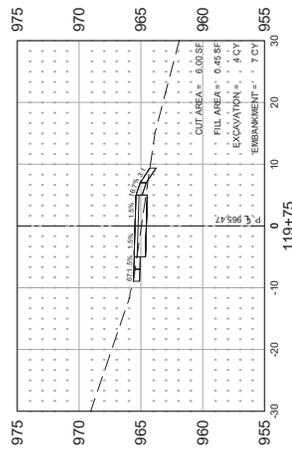
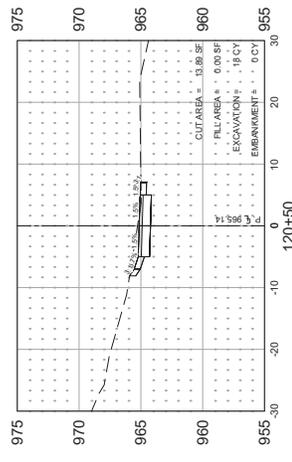
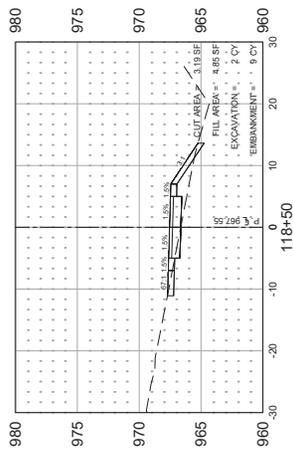
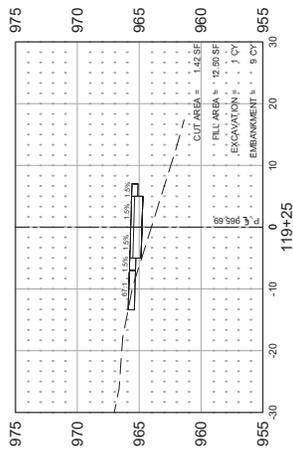
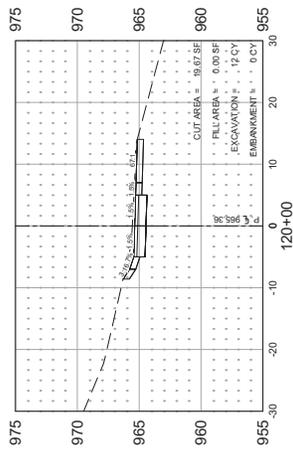
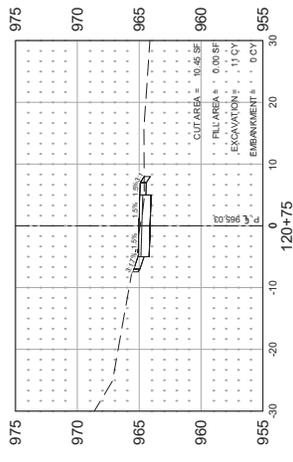
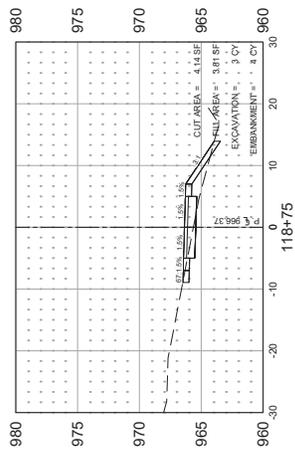
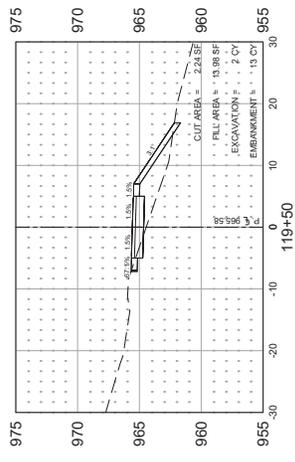
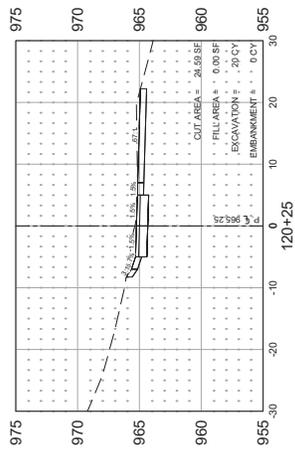
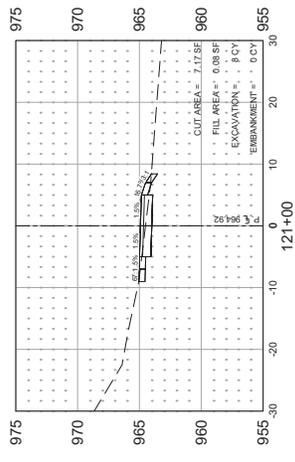


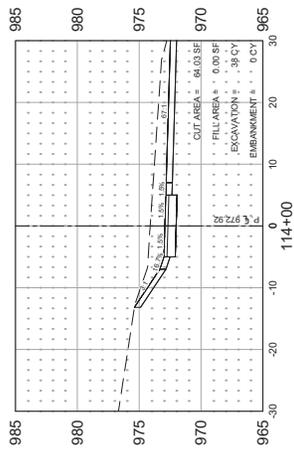
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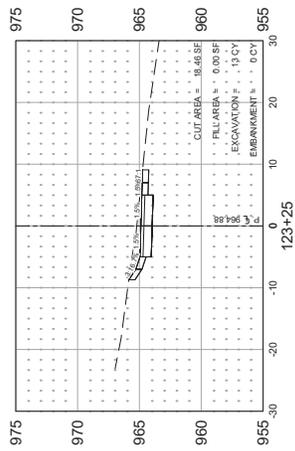
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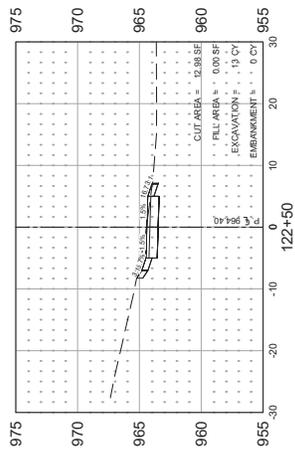


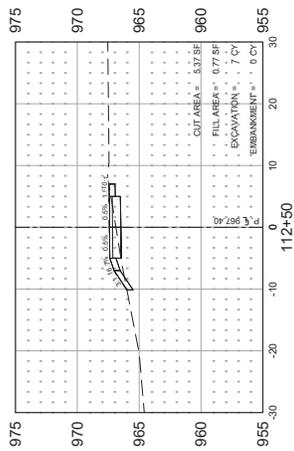


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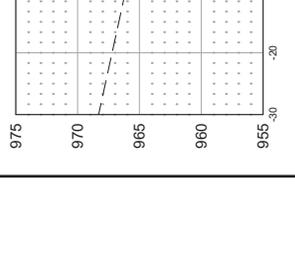
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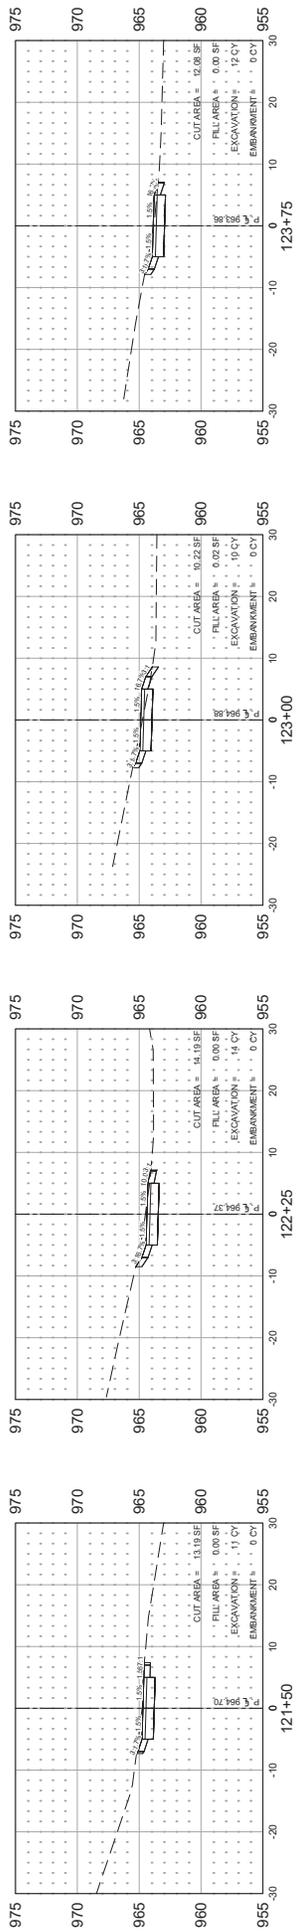
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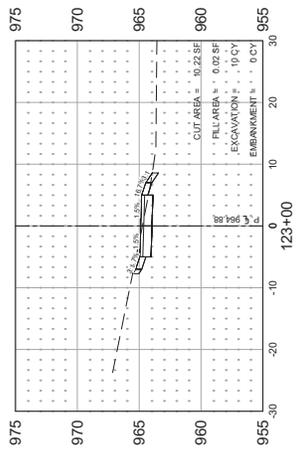
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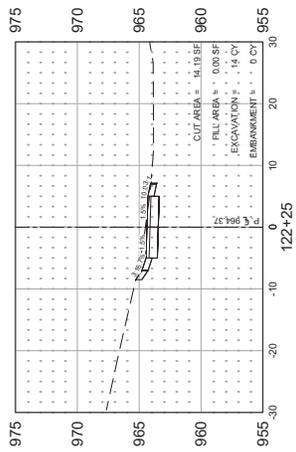
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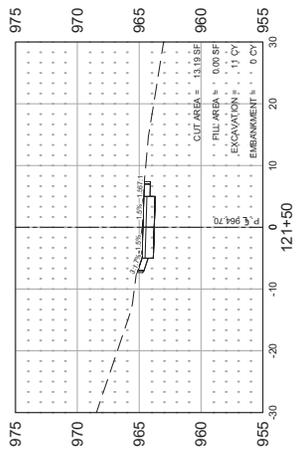
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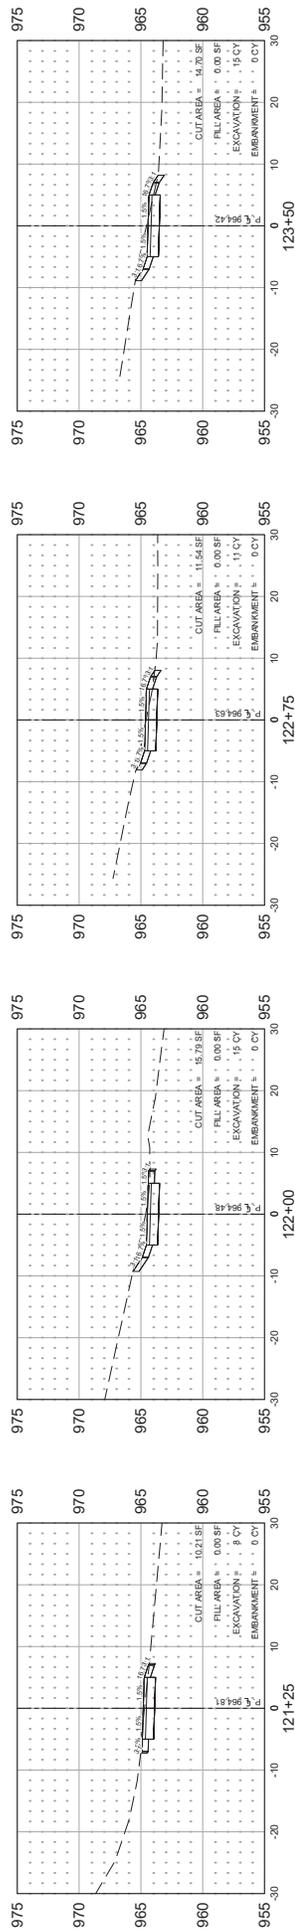
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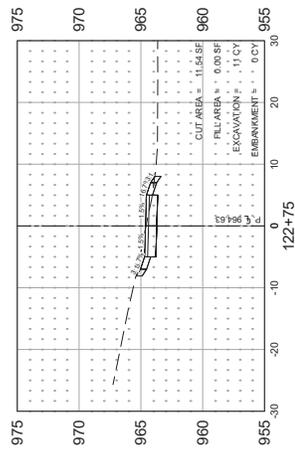
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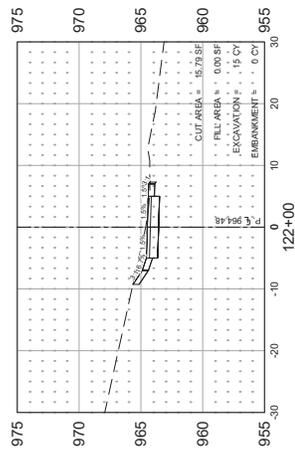
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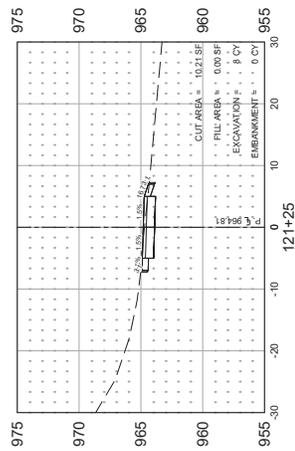
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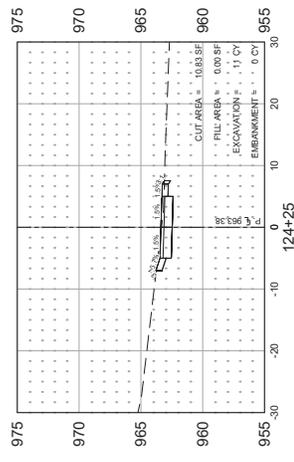
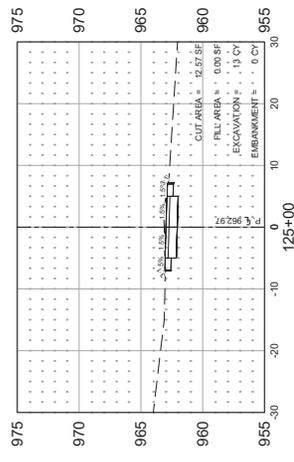
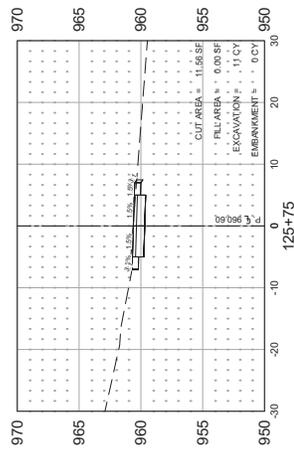
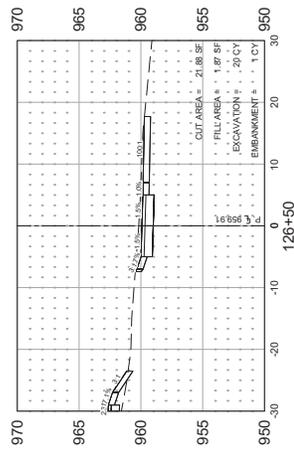
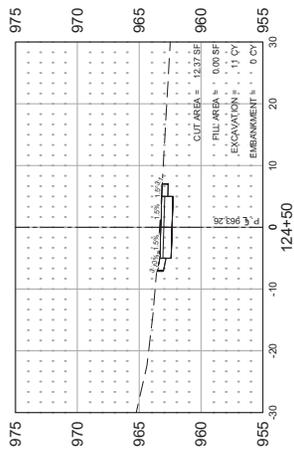
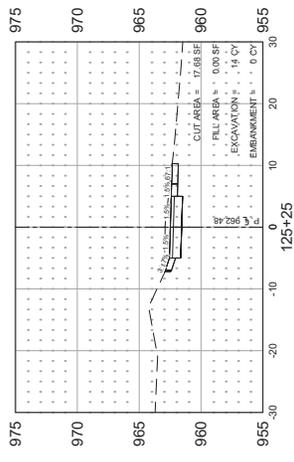
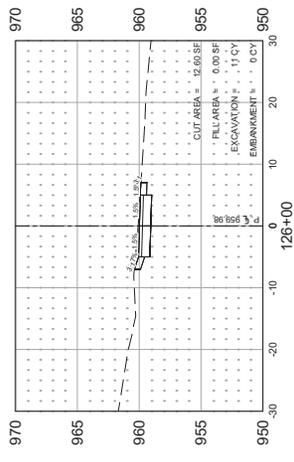
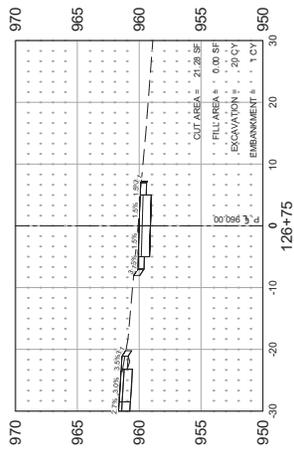
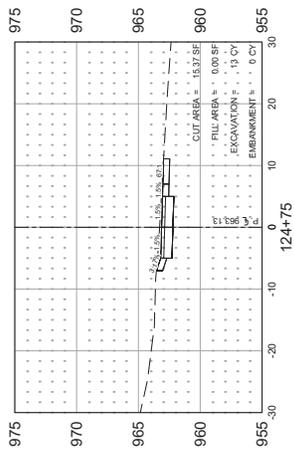
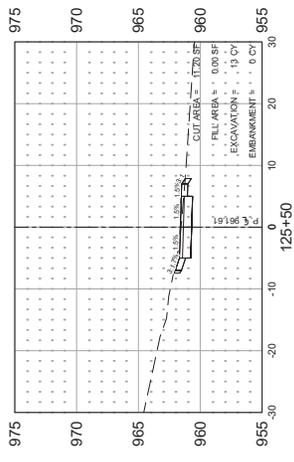
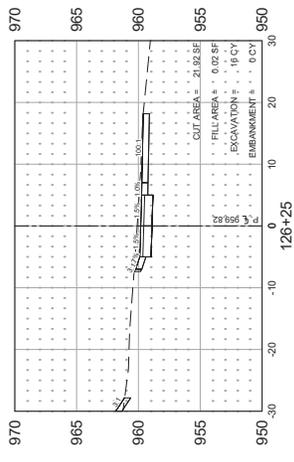
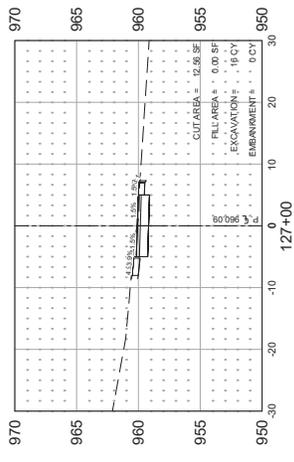
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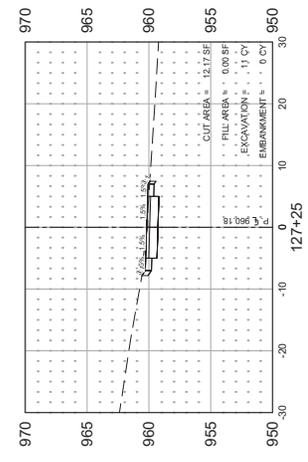
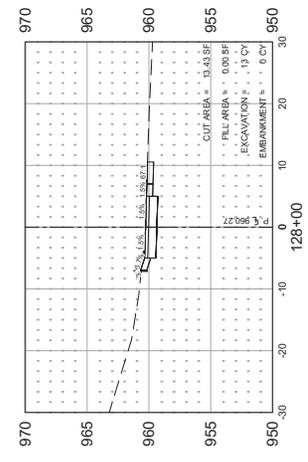
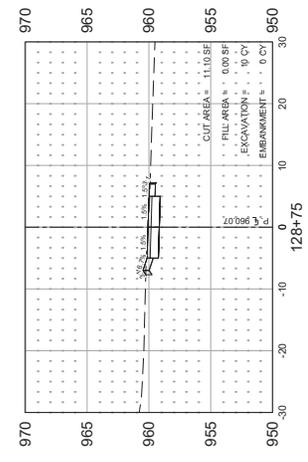
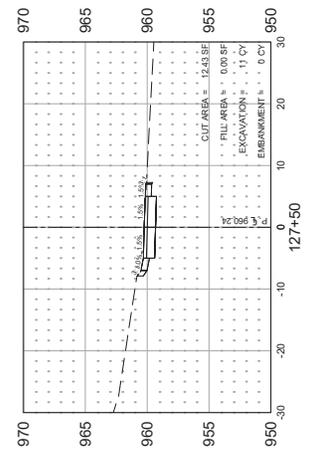
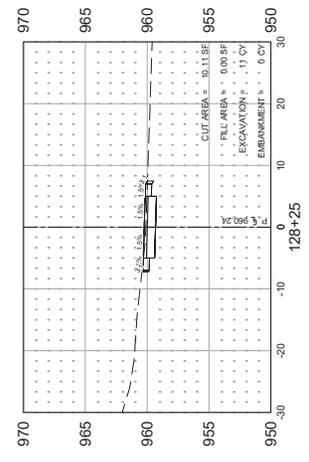
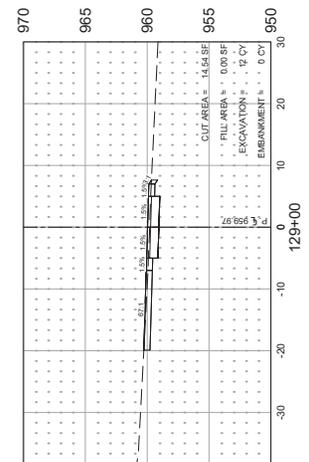
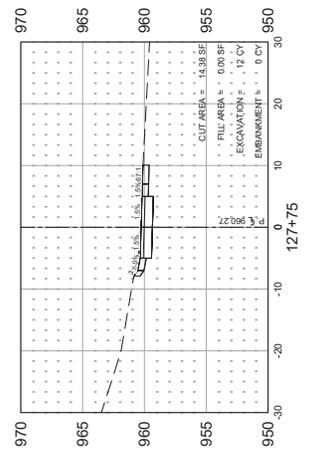
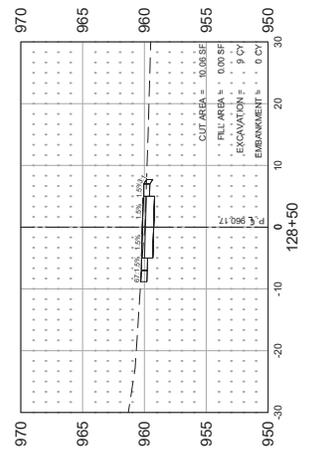
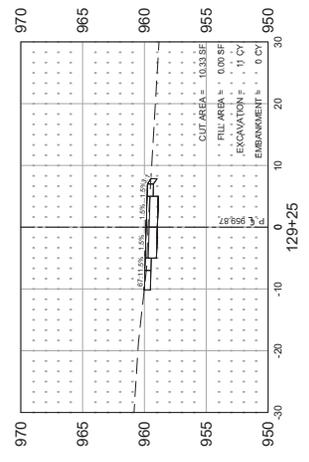














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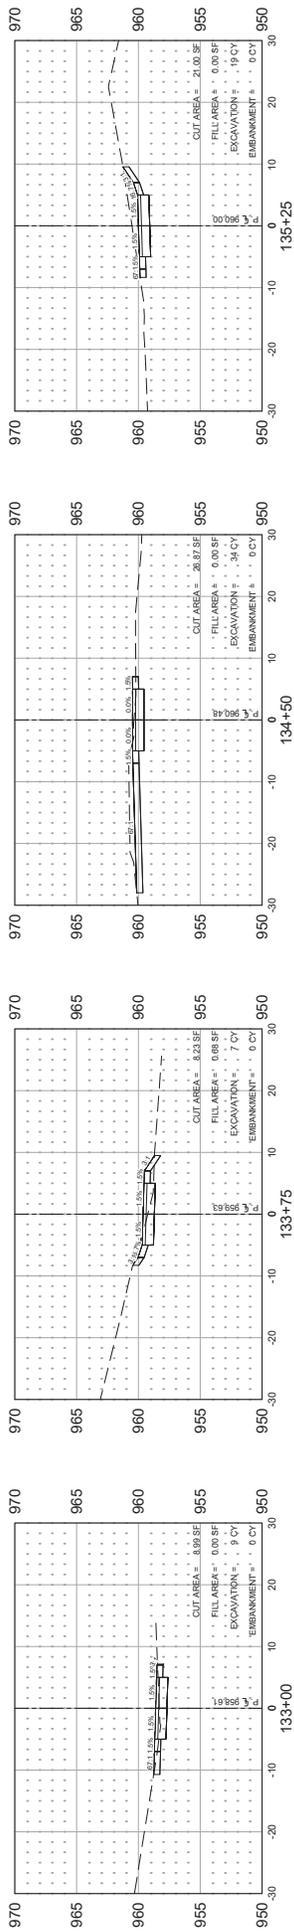

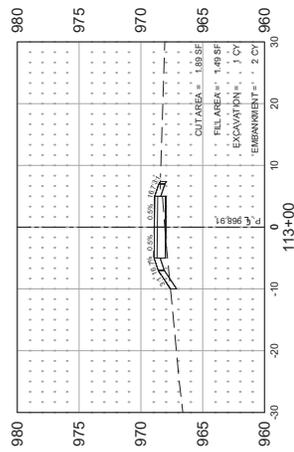
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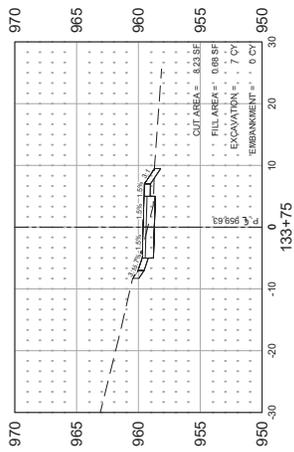


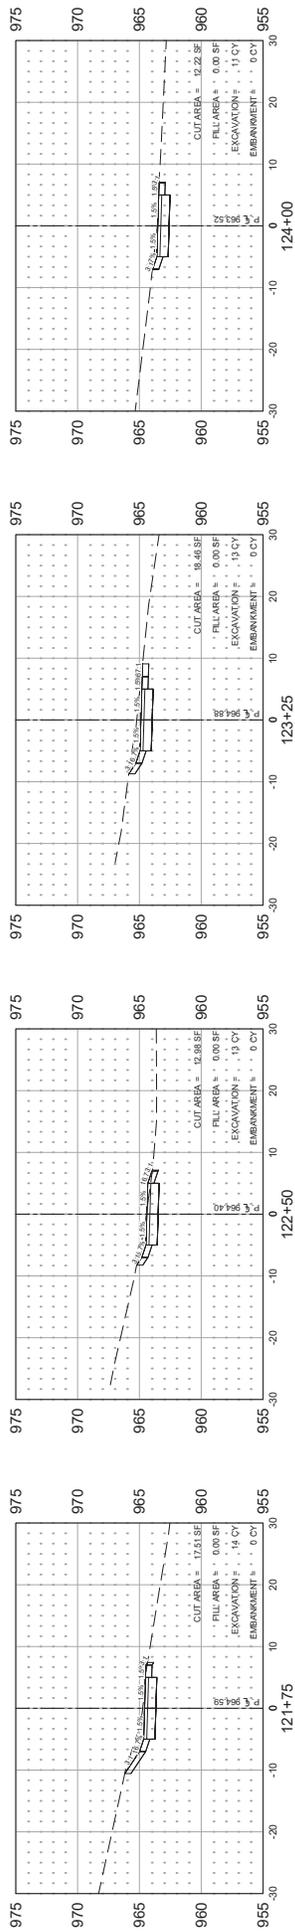




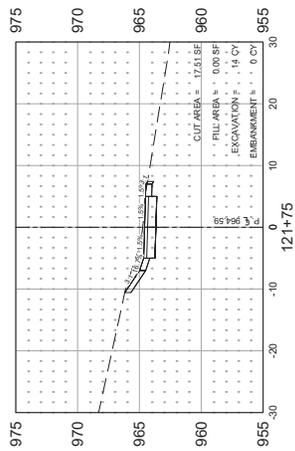

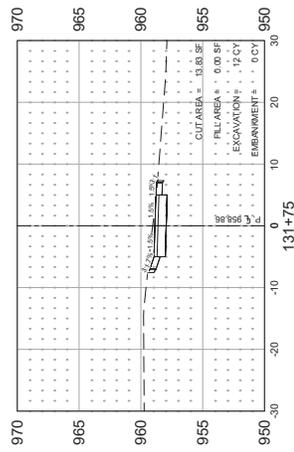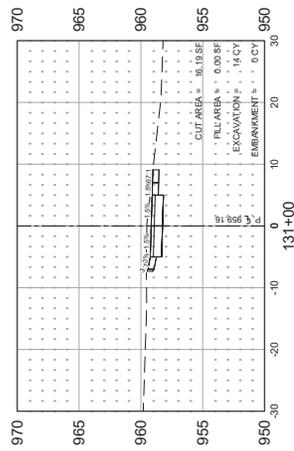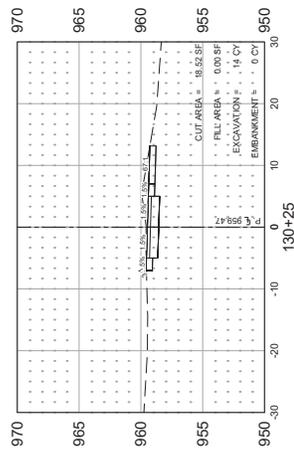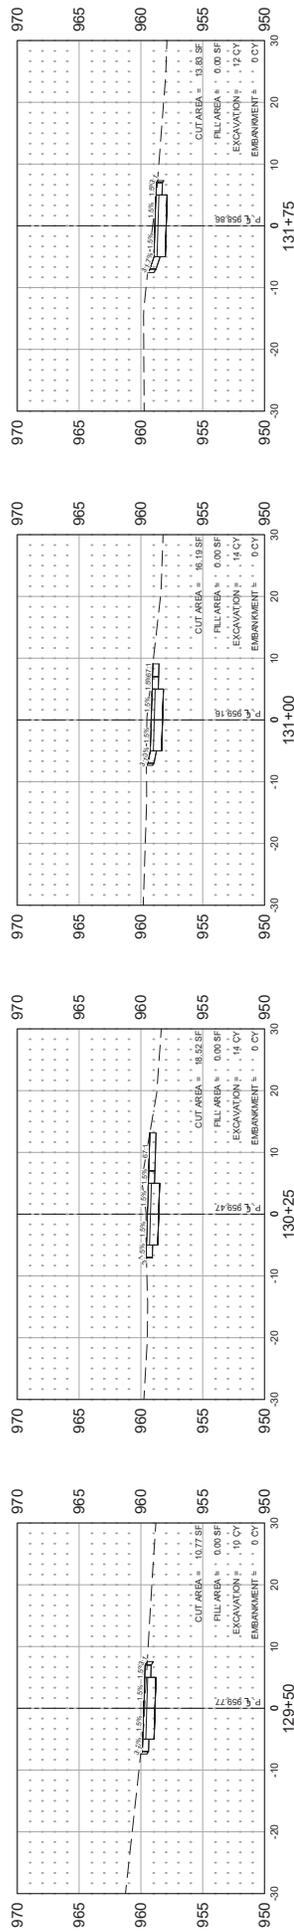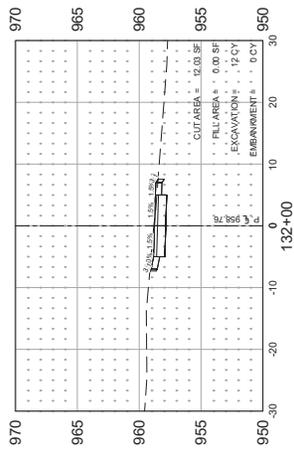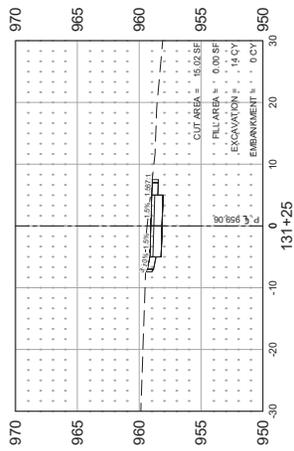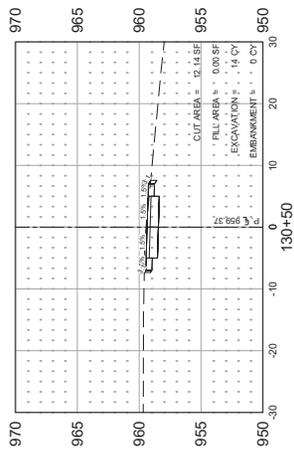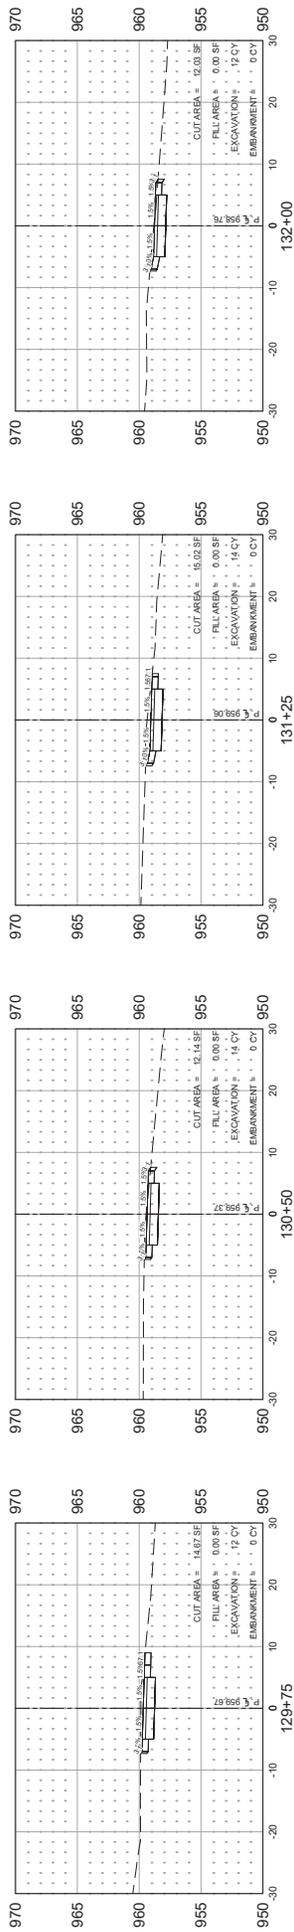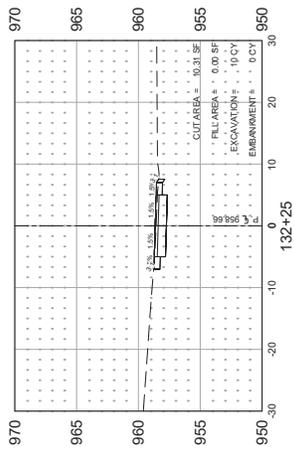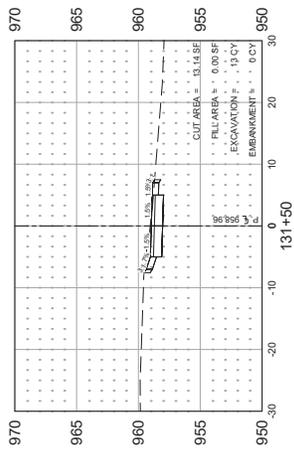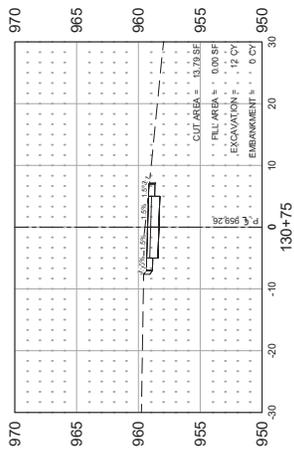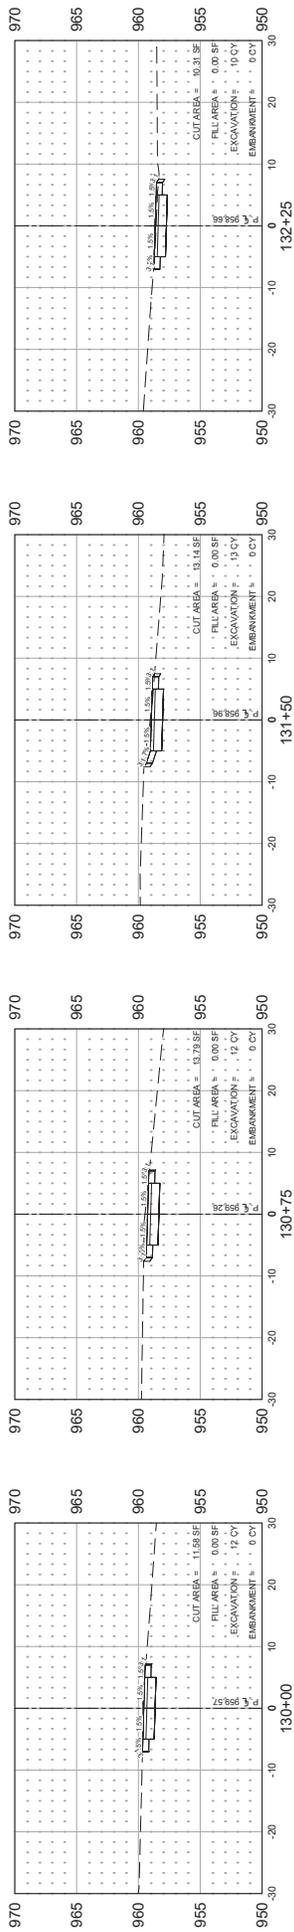133+00



133+25

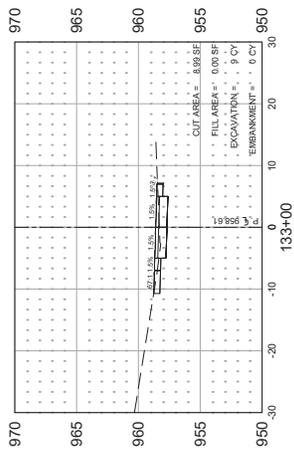

133+50



133+75


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134+25


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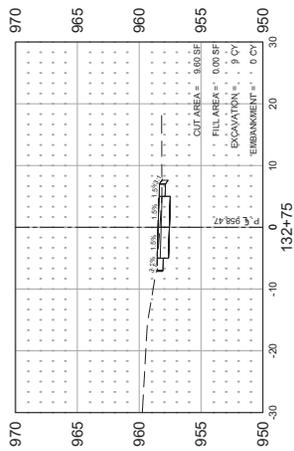
135+00



132+00

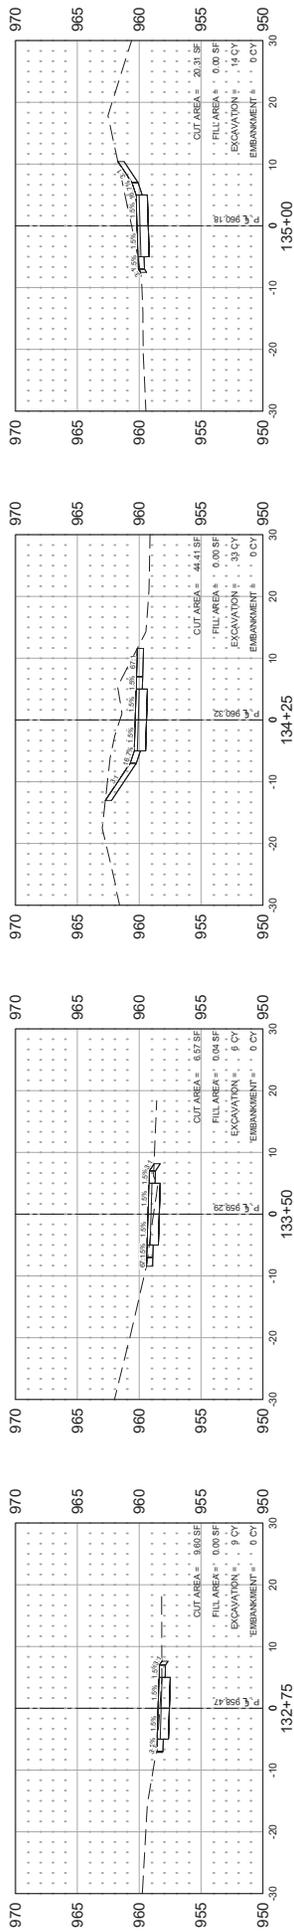

132+25

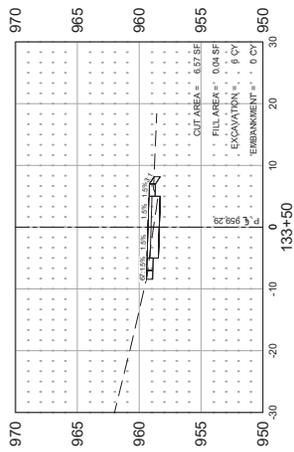

132+50



132+75

133+00

133+25

133+50

133+75













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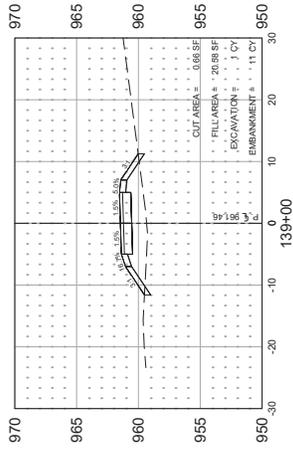
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134+50


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135+00






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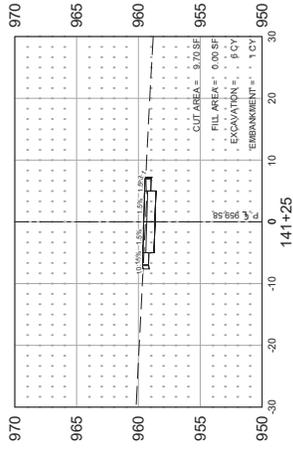

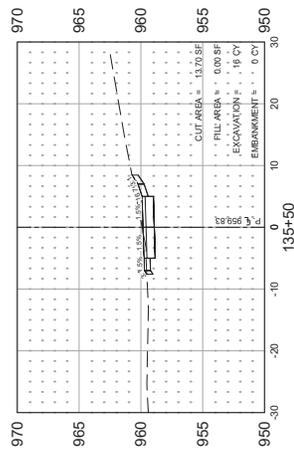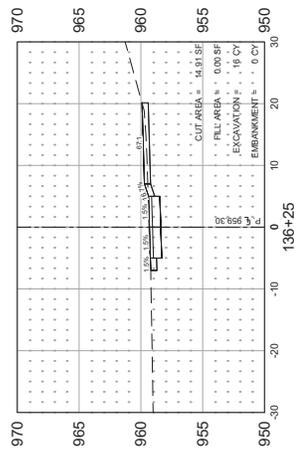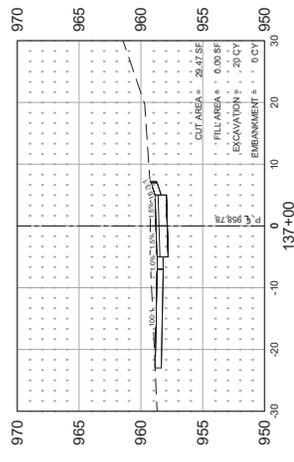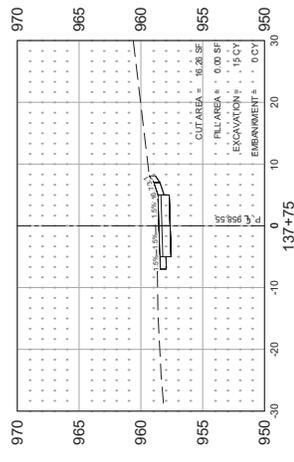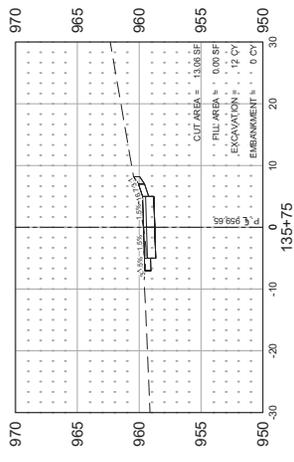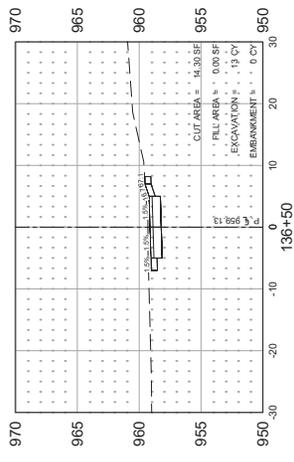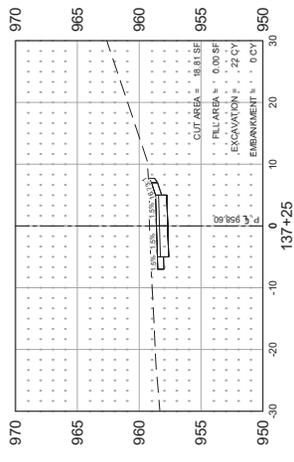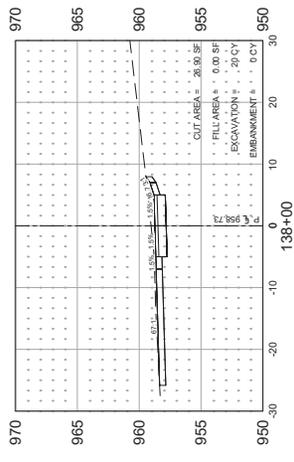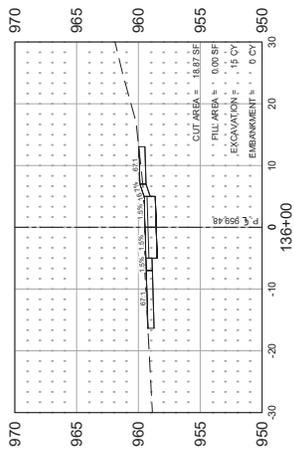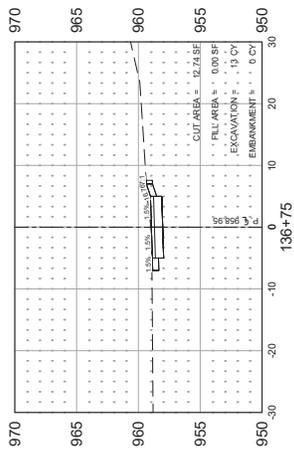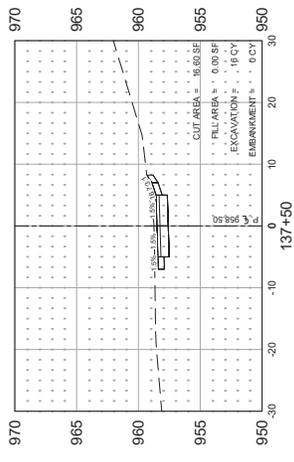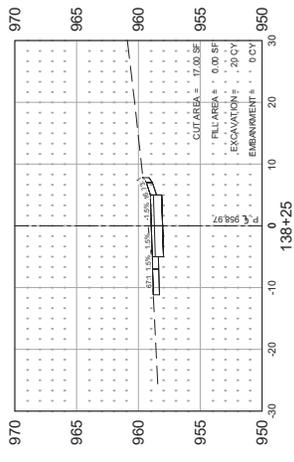
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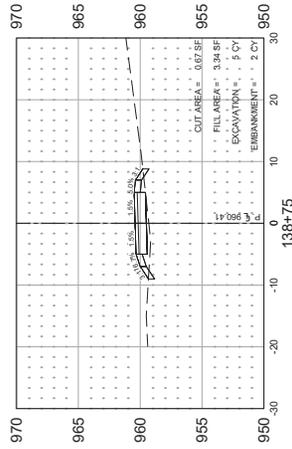
EXISTING BOARDWALK B

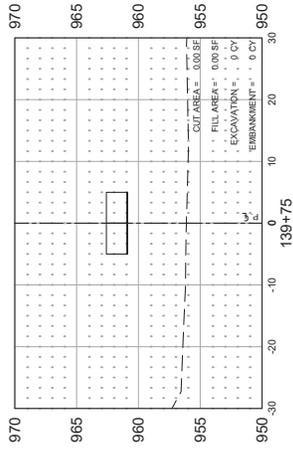


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141+25

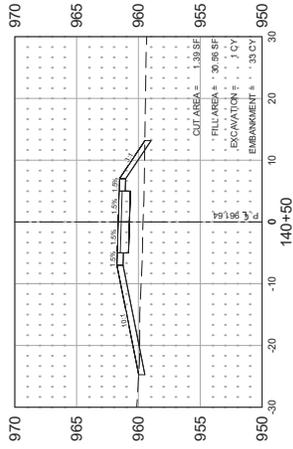


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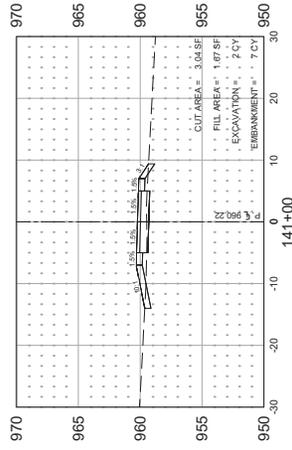


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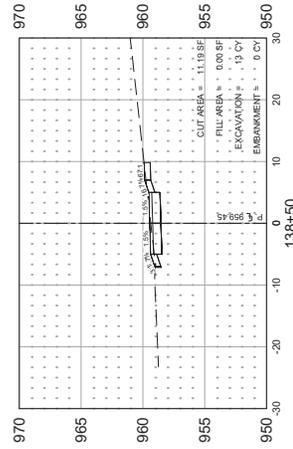
EXISTING BOARDWALK B

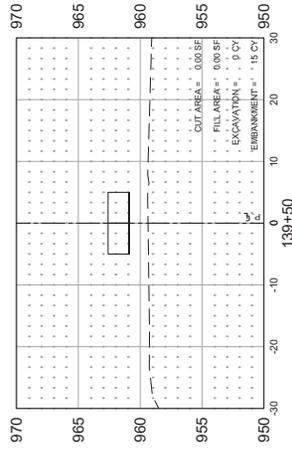


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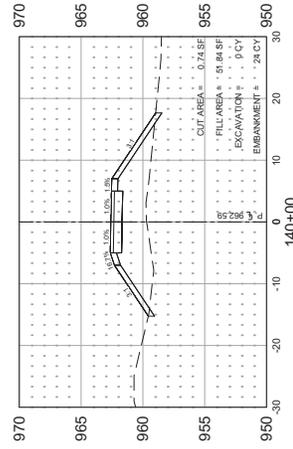
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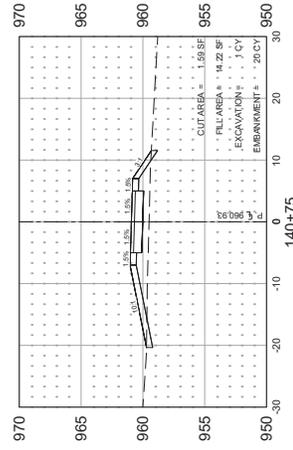
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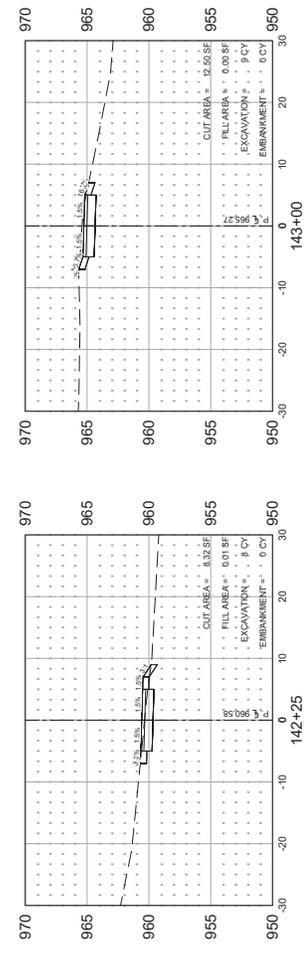
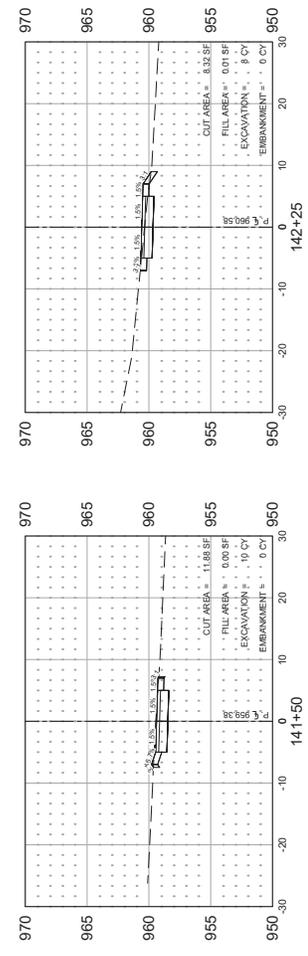
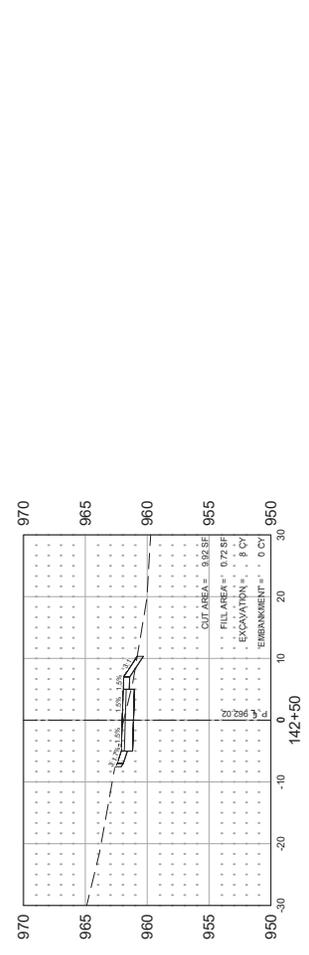
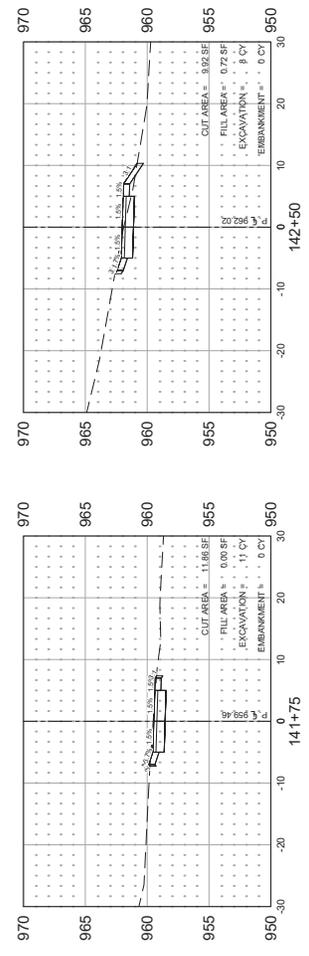
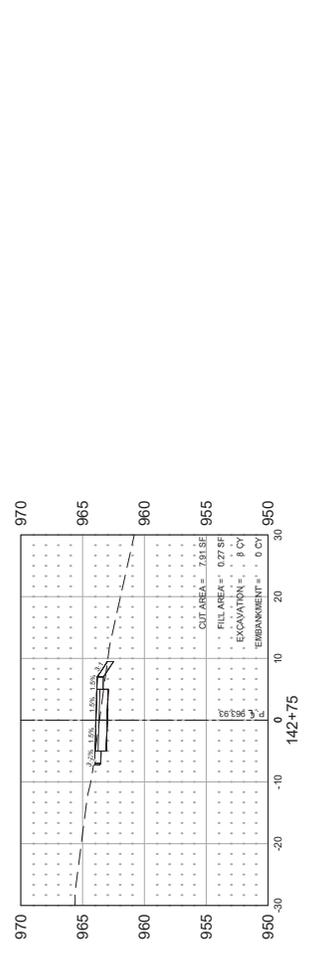
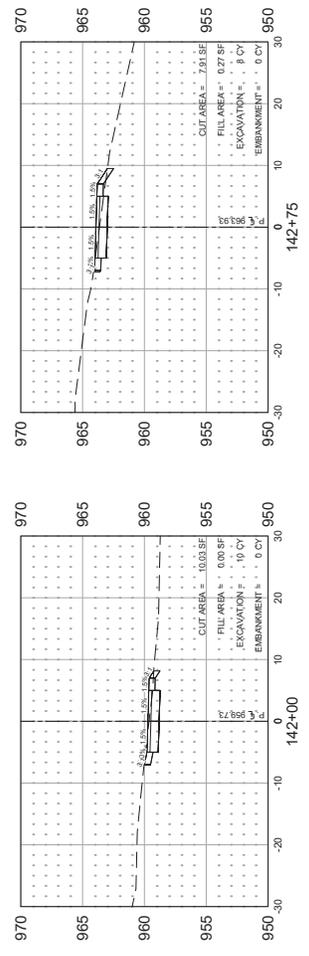
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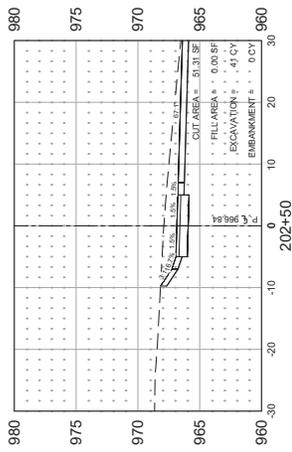
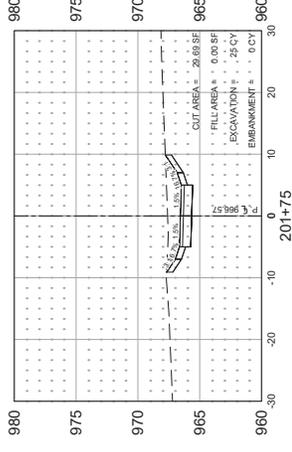
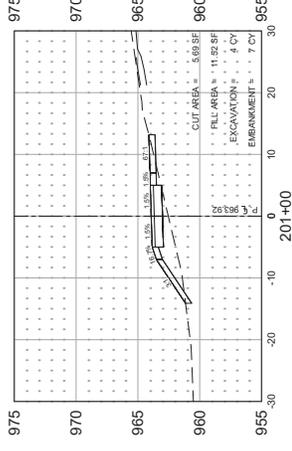
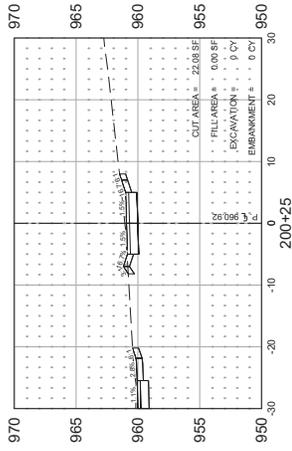
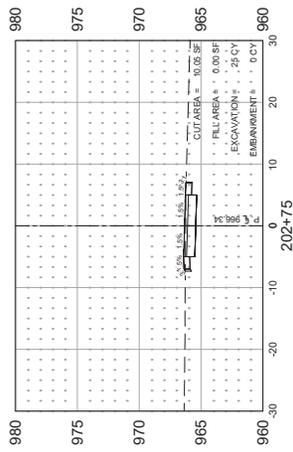
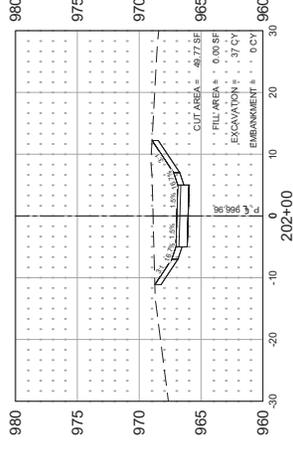
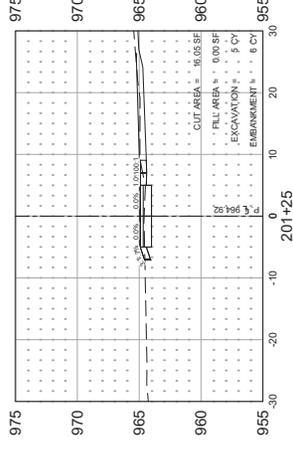
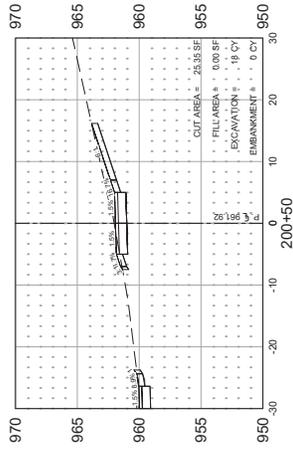
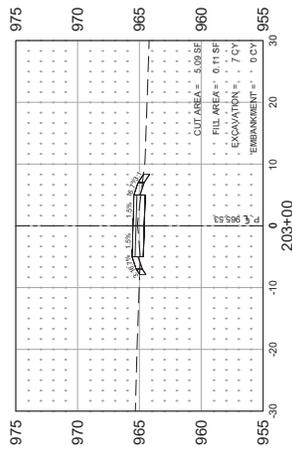
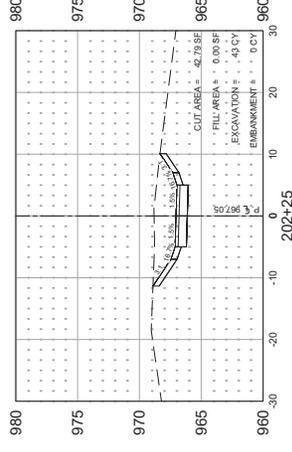
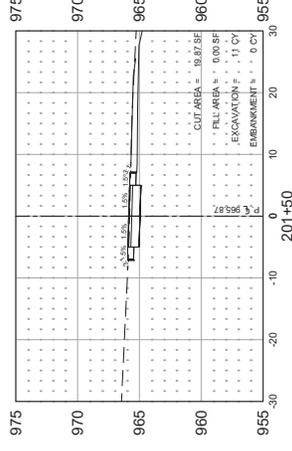
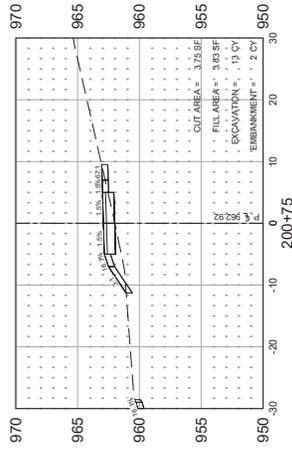













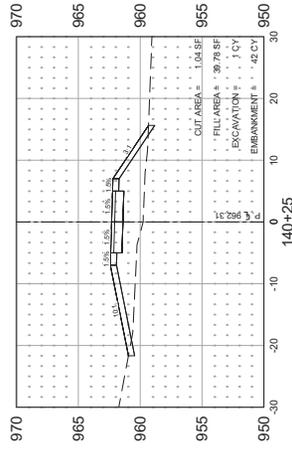
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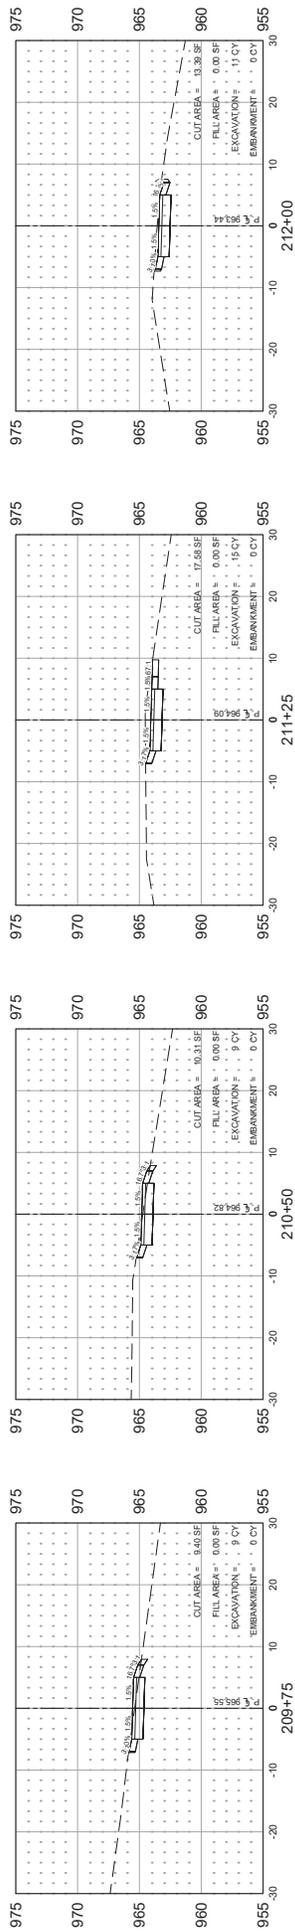


140+75






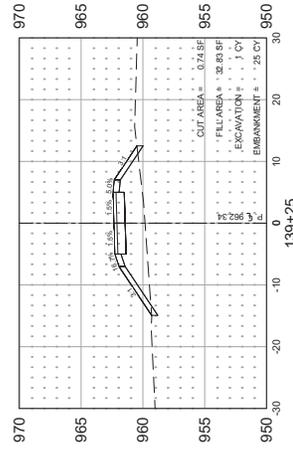


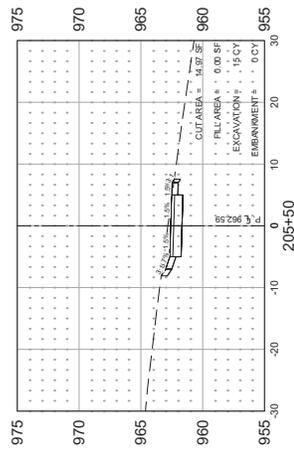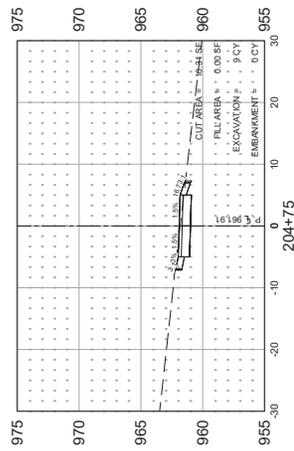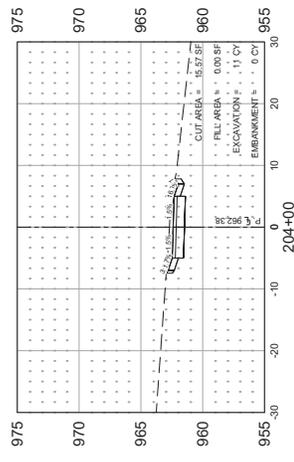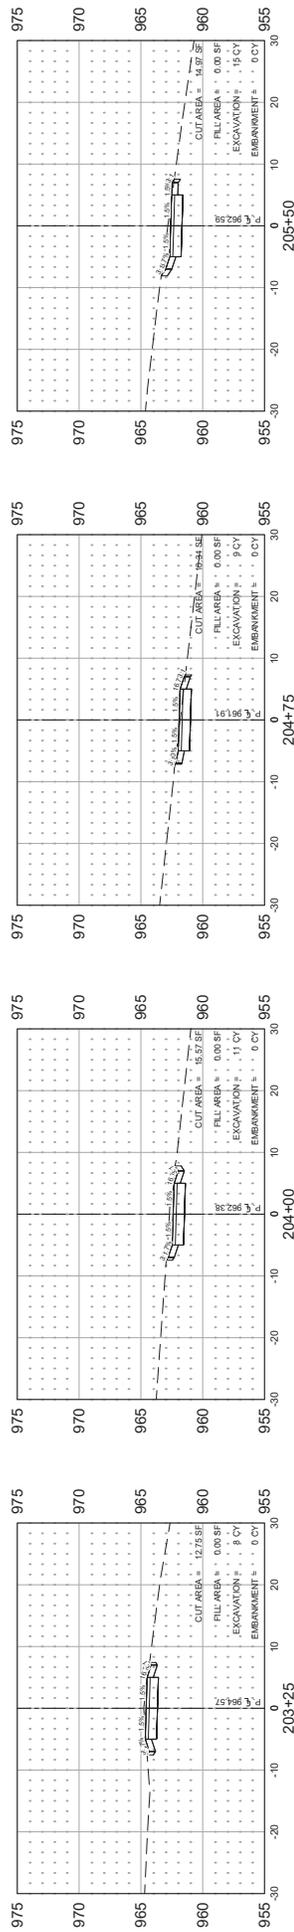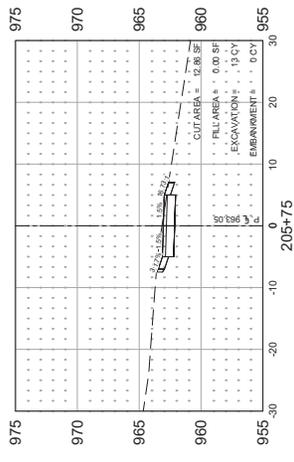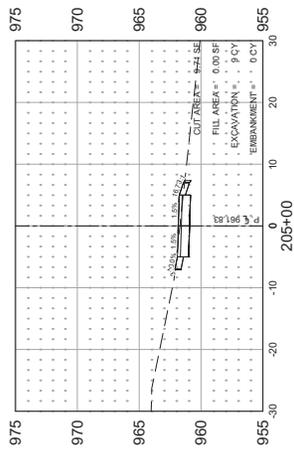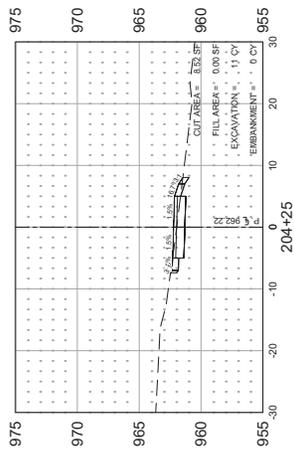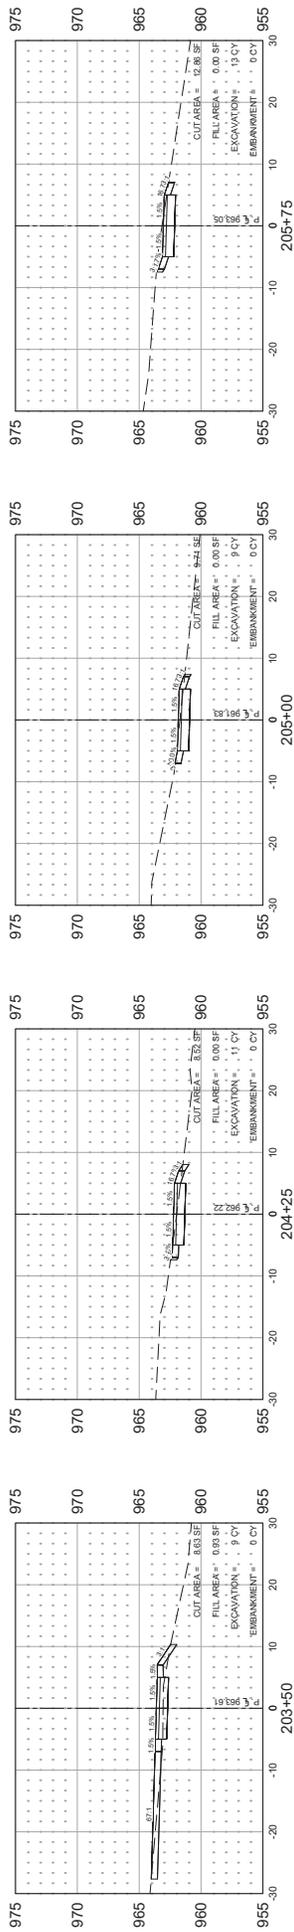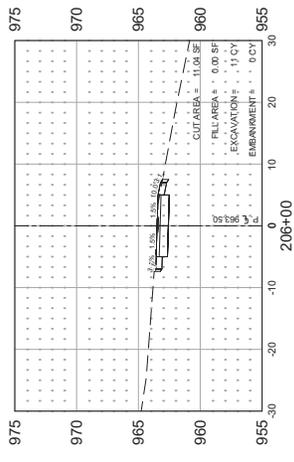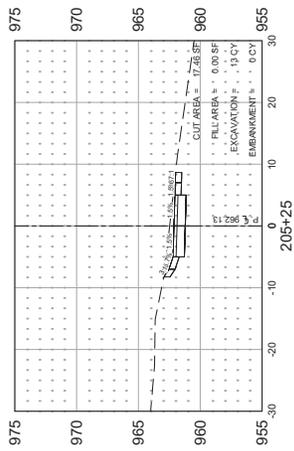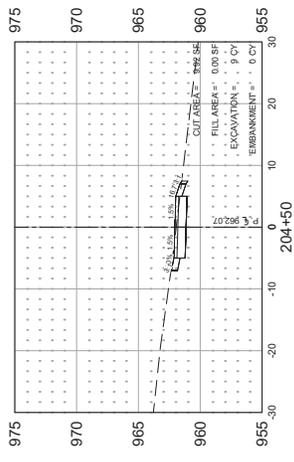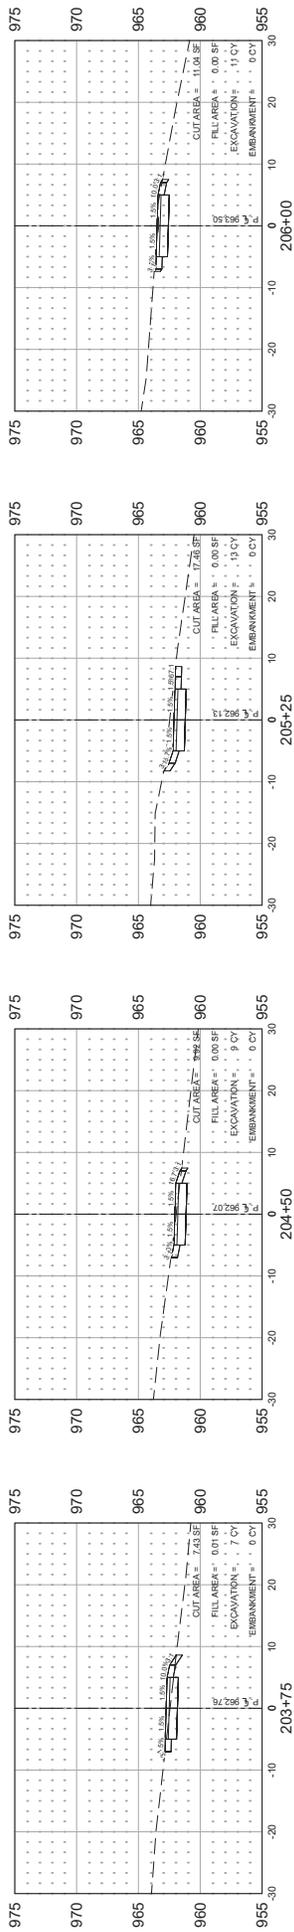


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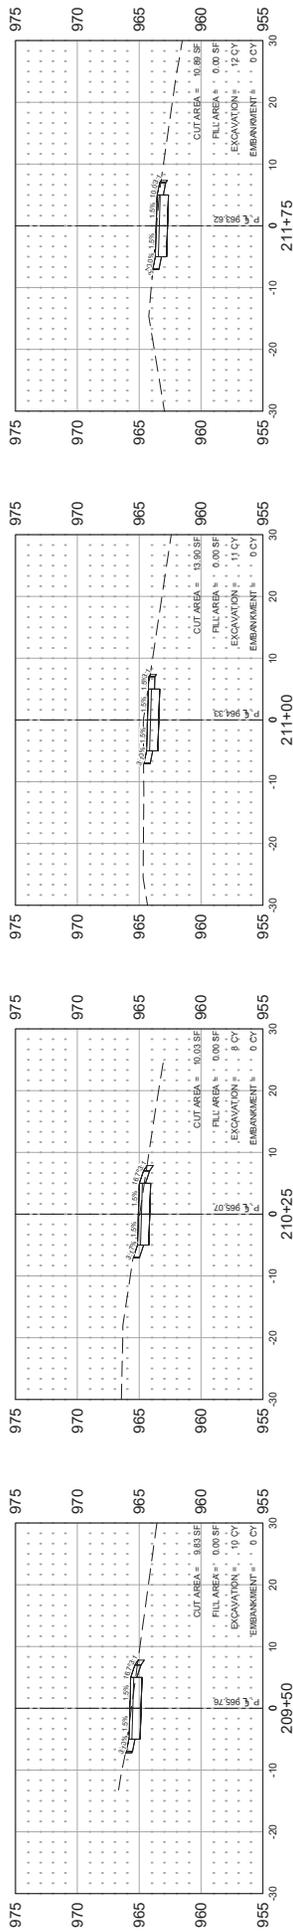
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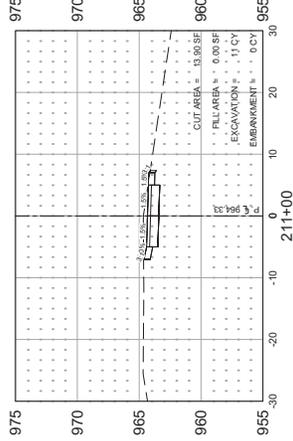
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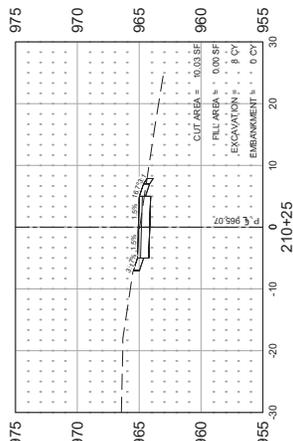
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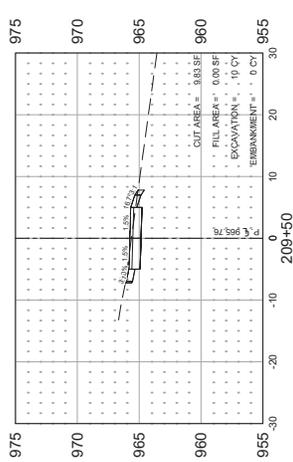
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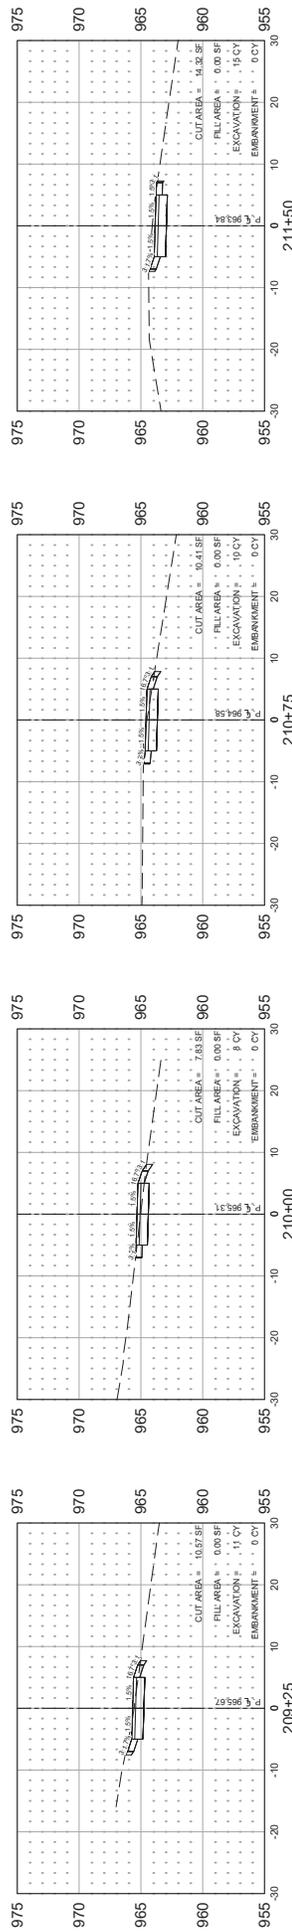
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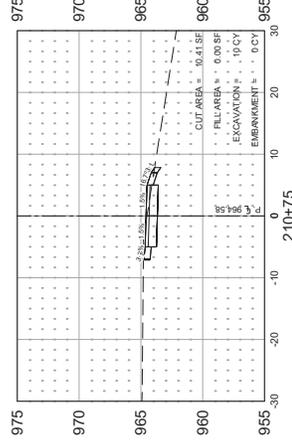
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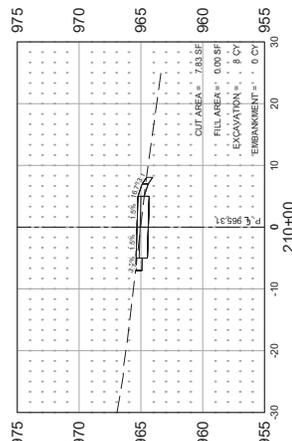
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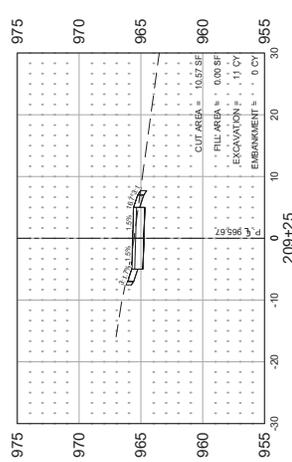
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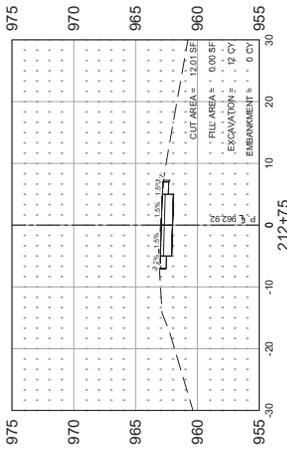
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210+75

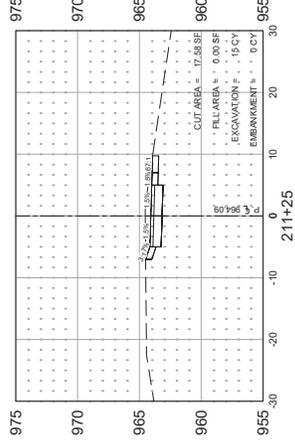


211+50

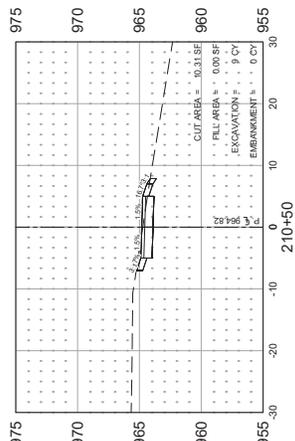


212+75

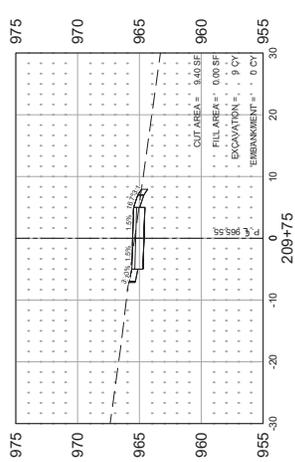EXISTING BOARDWALK C

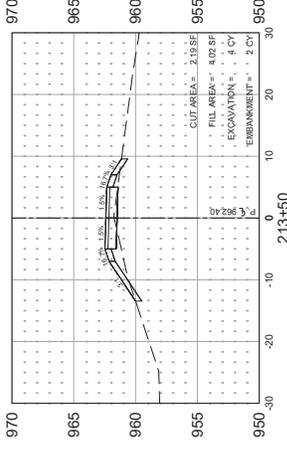


213+50

EXISTING BOARDWALK C

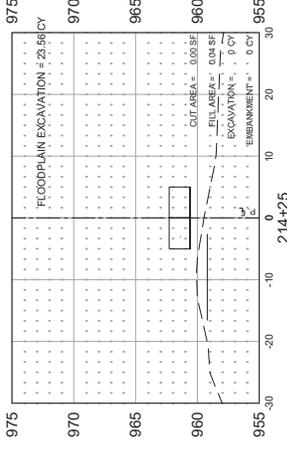


214+25

EXISTING BOARDWALK C

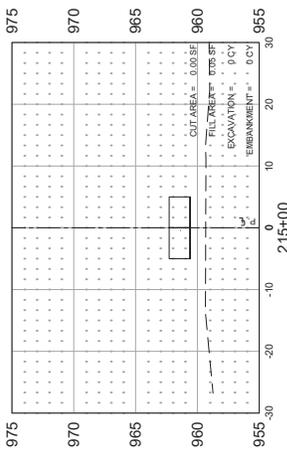


215+00

EXISTING BOARDWALK C

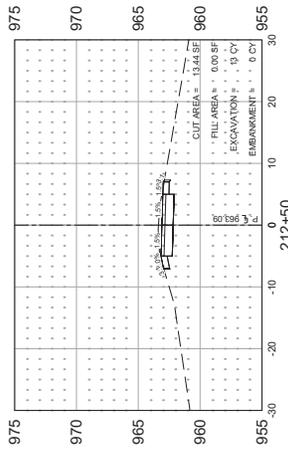


212+50

EXISTING BOARDWALK C

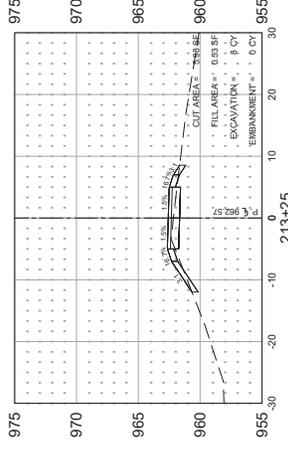


213+25

EXISTING BOARDWALK C

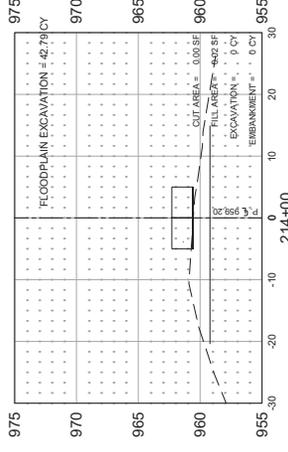


214+00

EXISTING BOARDWALK C

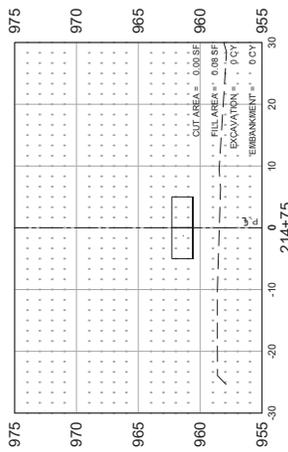


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EXISTING BOARDWALK C

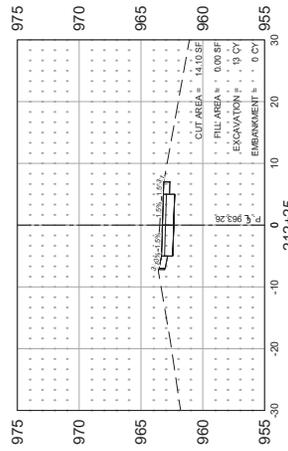


212+25

EXISTING BOARDWALK C

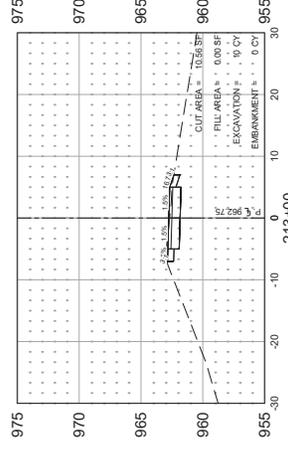


213+00

EXISTING BOARDWALK C

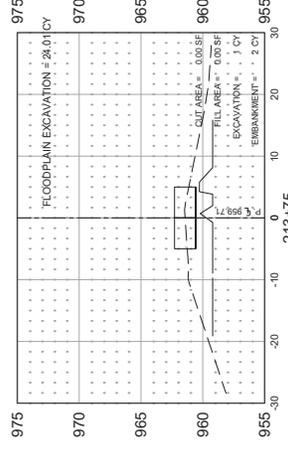


213+75

EXISTING BOARDWALK C

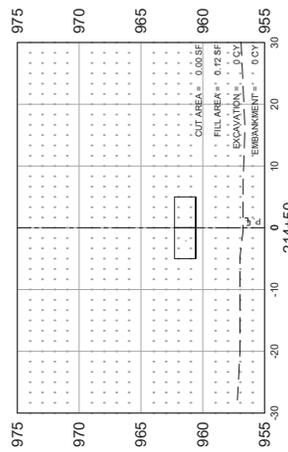


214+50


EXISTING BOARDWALK C

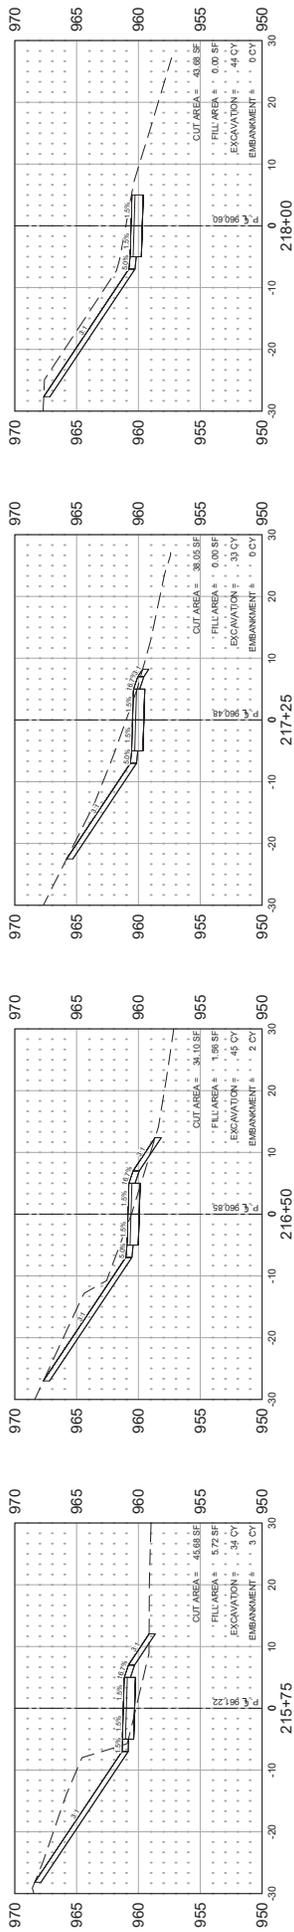


215+75

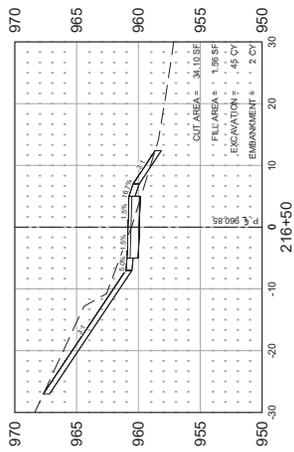


216+50

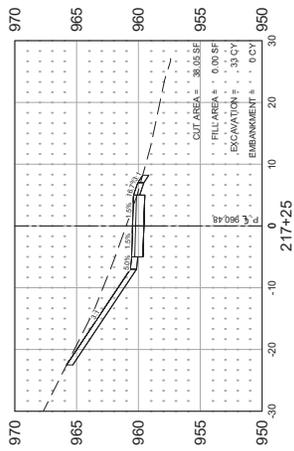


217+25

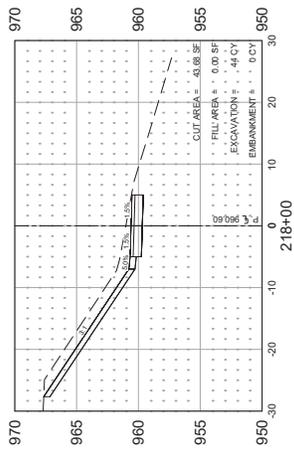


218+00

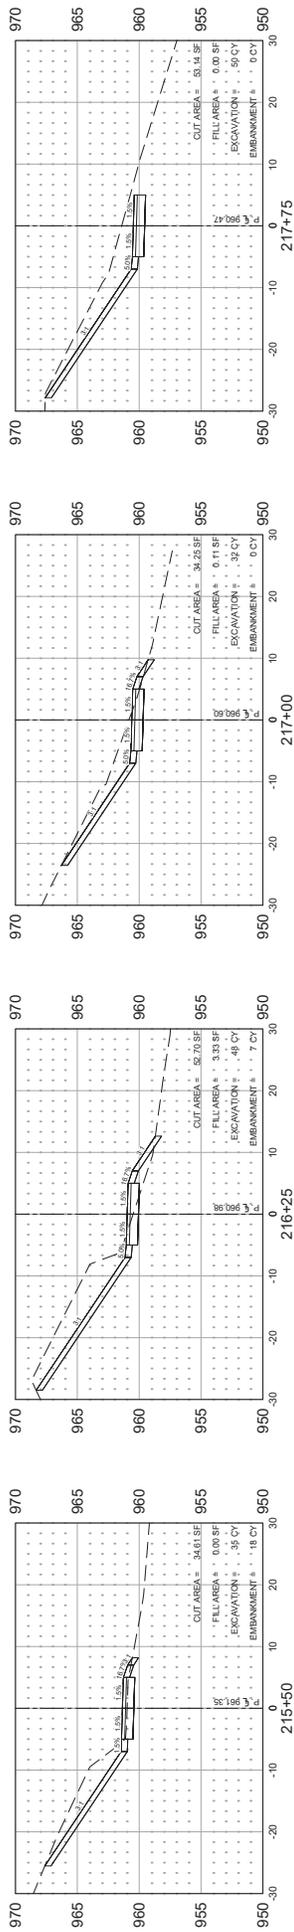


215+50

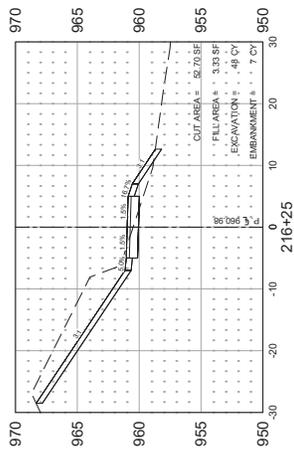


216+25

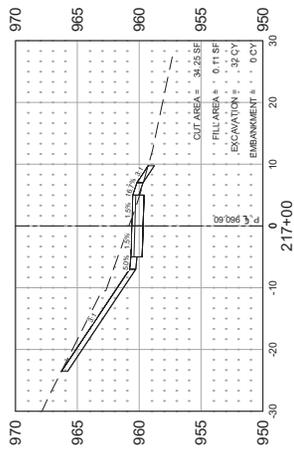













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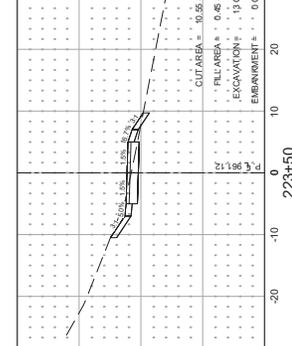
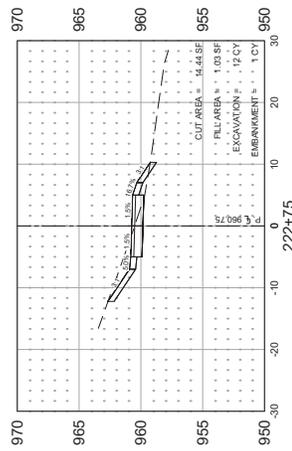
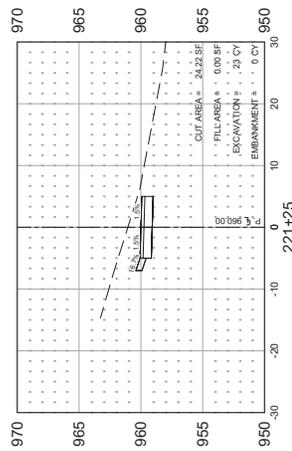
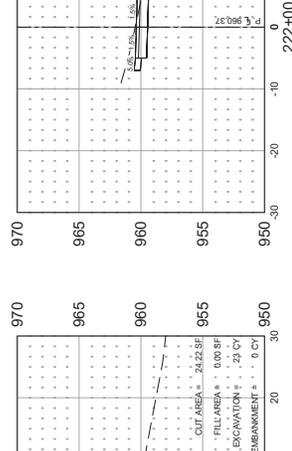
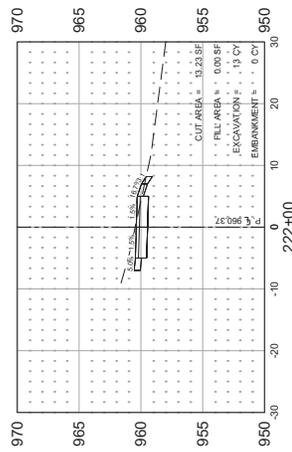
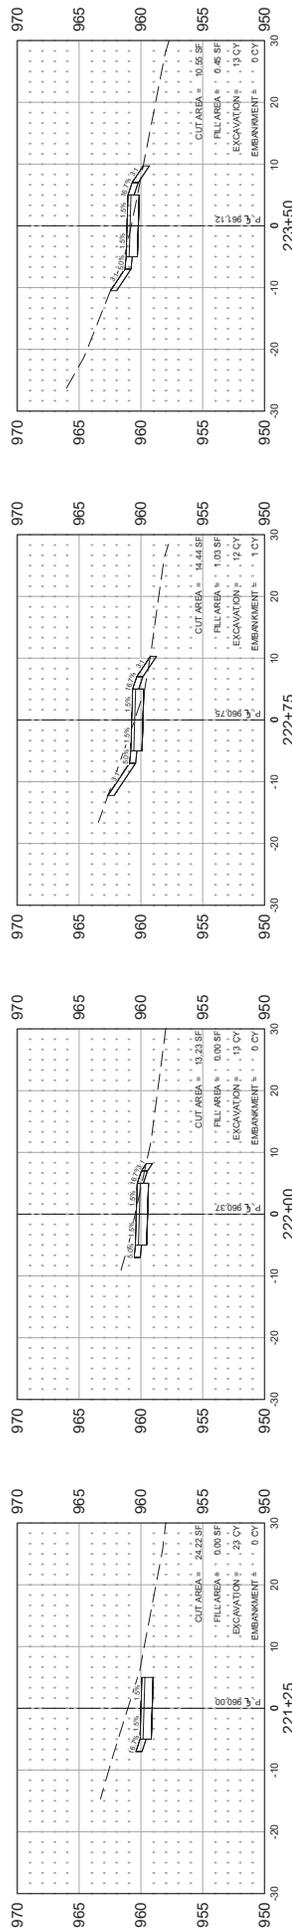
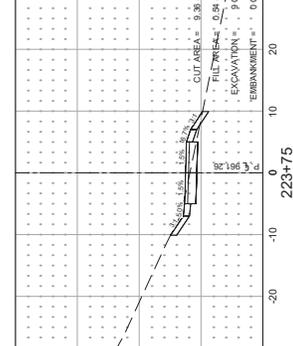
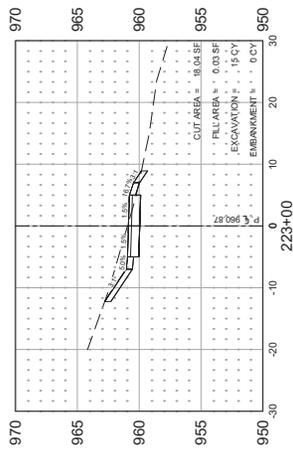
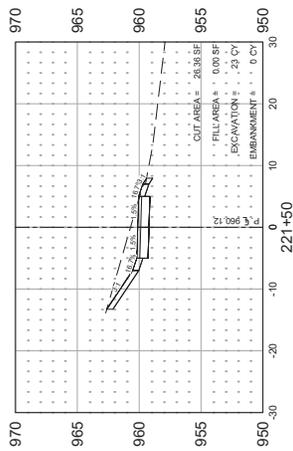
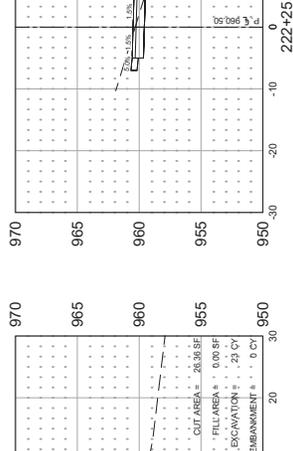
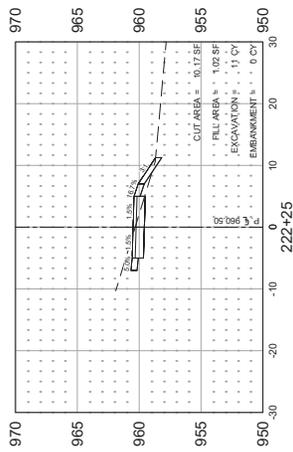
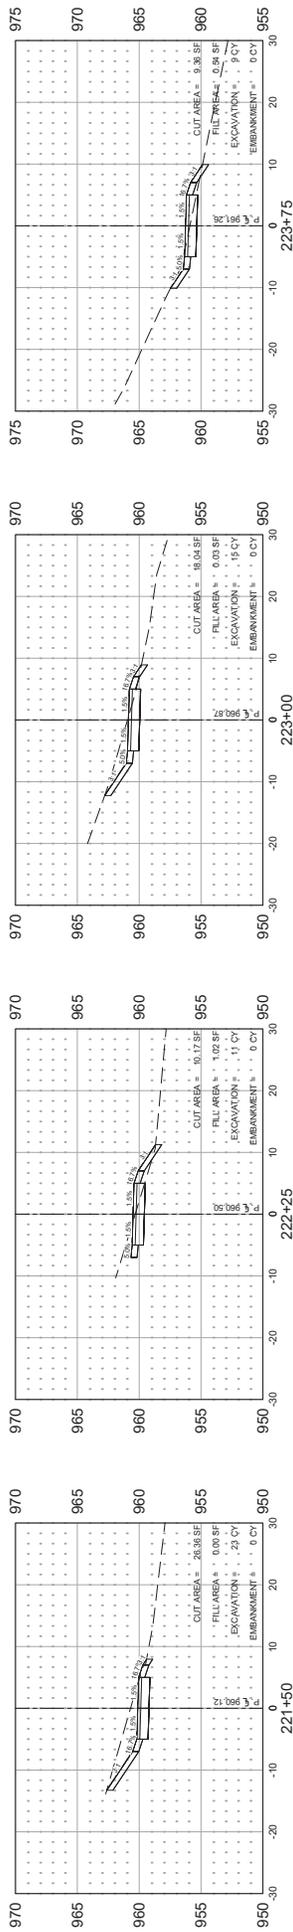
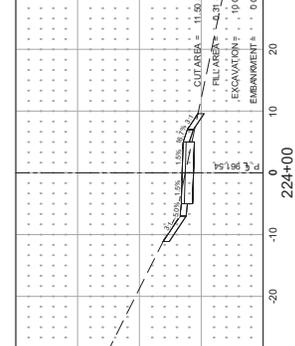
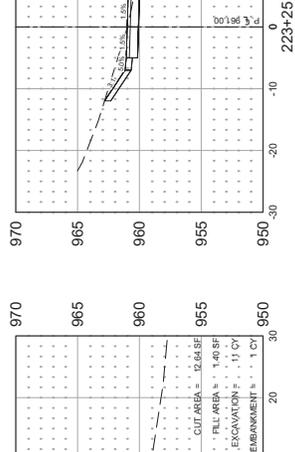
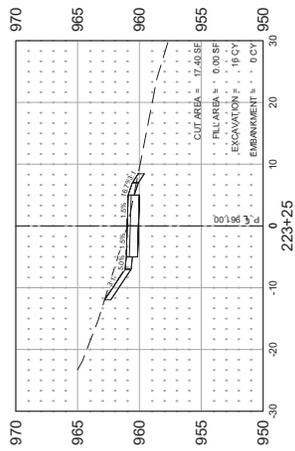
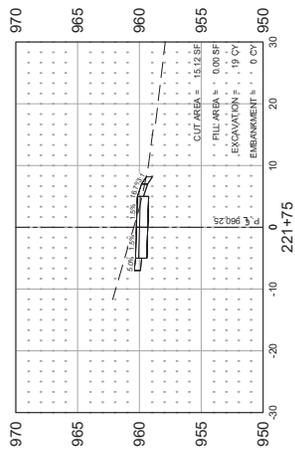
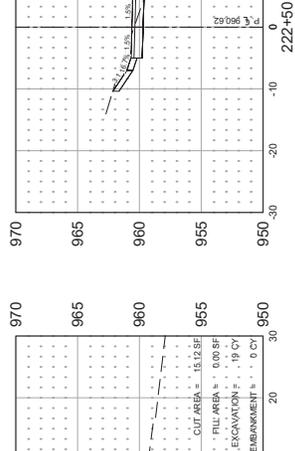
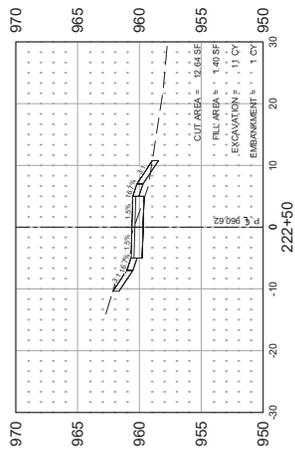
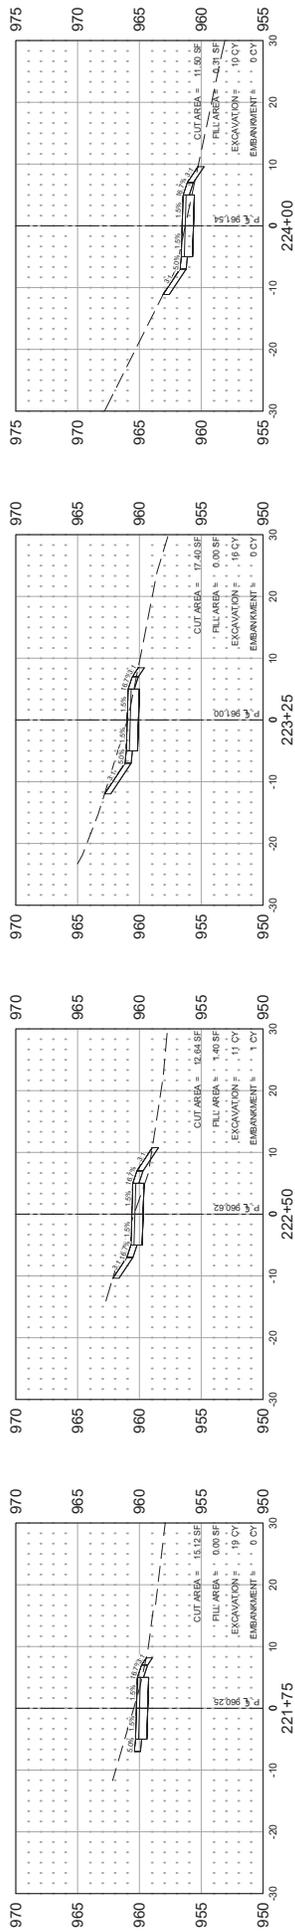






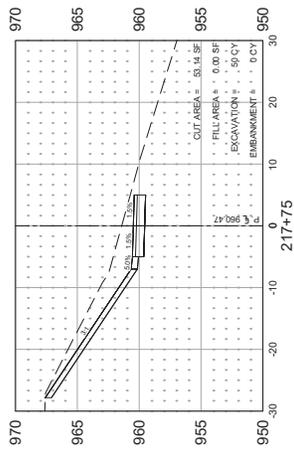
217+75

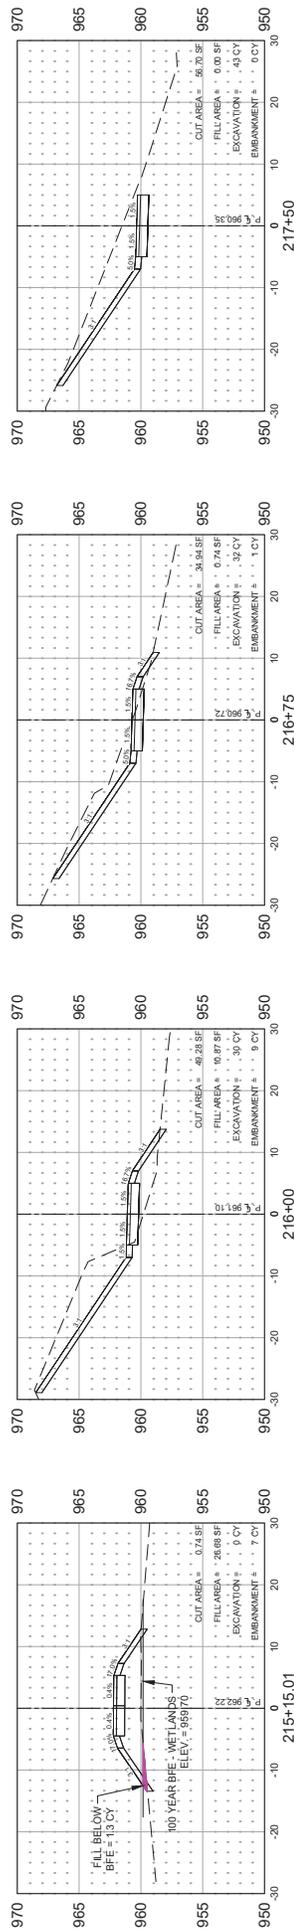

215+15.01



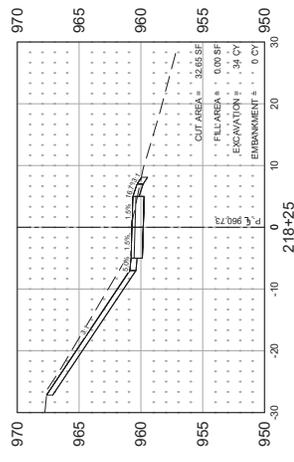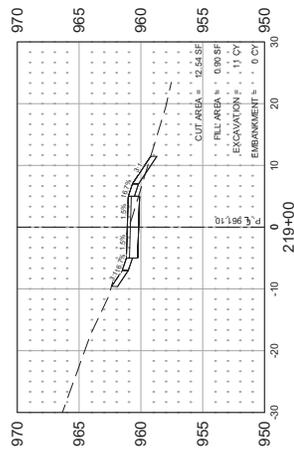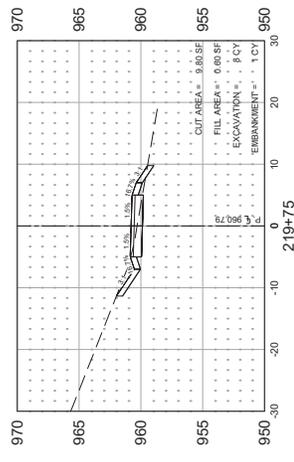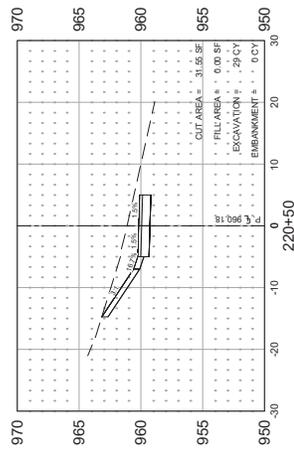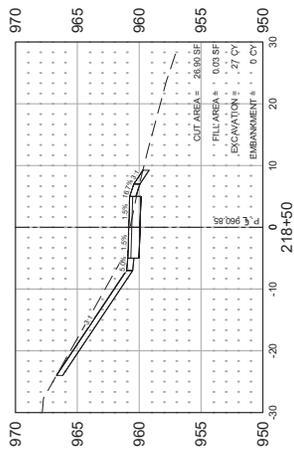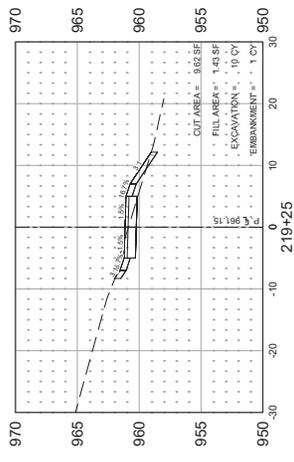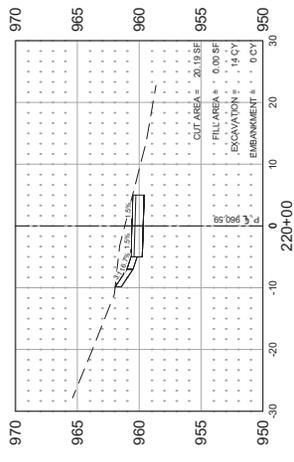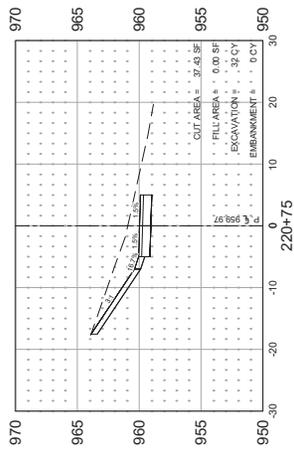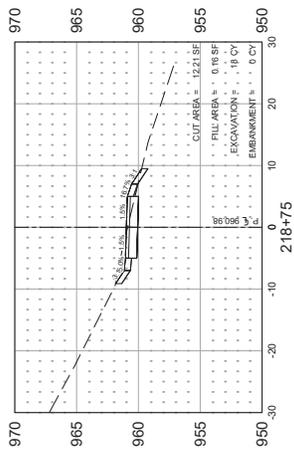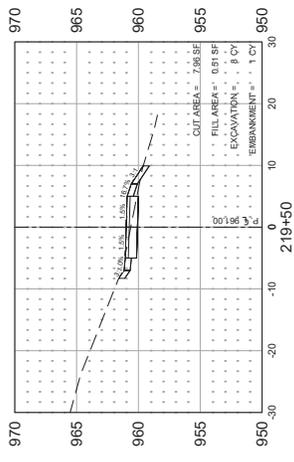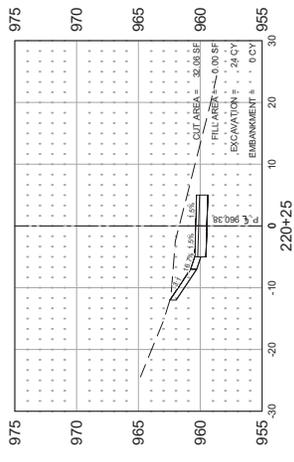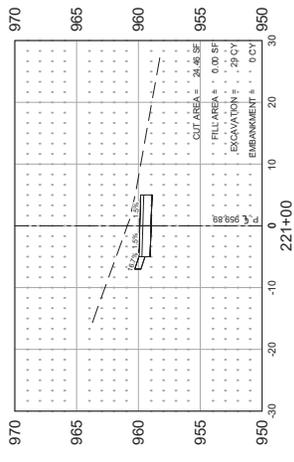

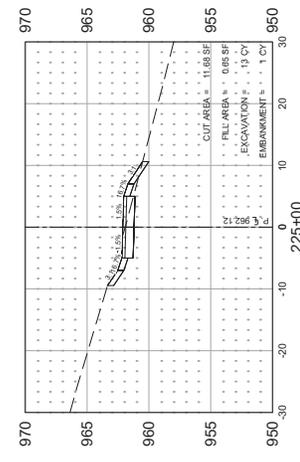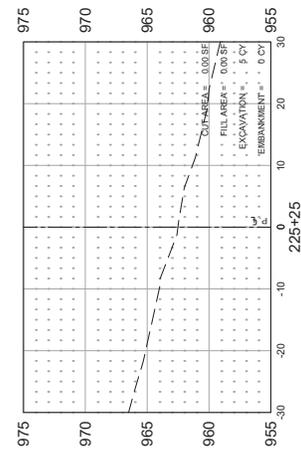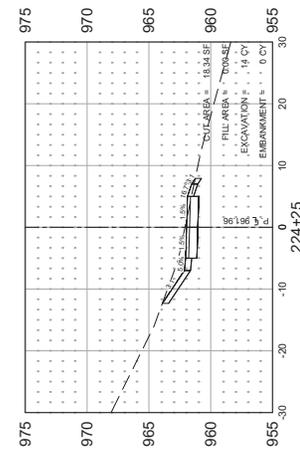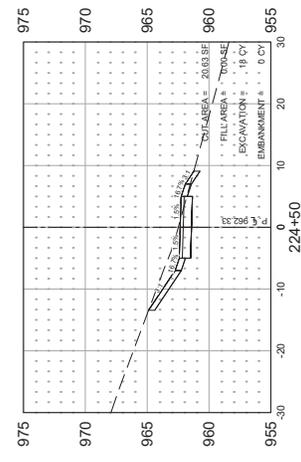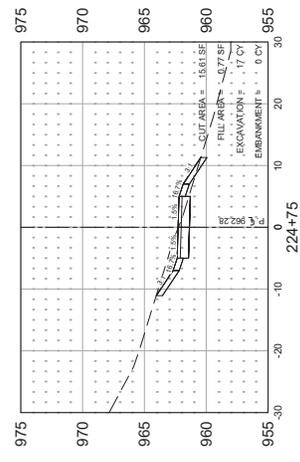



9' CLASS 5 AGGREGATE BASE
(MNDOT 31.3B)

NON-PAVED TRAIL TYPICAL

BOARDWALK APPROACHES

BOARDWALKS

SEE SHEET B4 FOR BOARDWALK TYPICAL SECTIONS

Revision Issue
Description

Rev #

Date

90% PRELIMINARY

SEH PROJECT

H018177684

Drawn By

Designed By

Checked By

SEH

LAKE ANN PARK PRESERVE
BOARDWALK IMPROVEMENT PROJECT

CHANHASSEN, MN

5
of 7

TYPICAL SECTIONS


DATE: 12-28-2023

USER NO: 44581

HEREBY CERTIFY THAT THIS PLAN WAS PREPARED BY ME OR UNDER MY DIRECT
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IN THE STATE OF MINNESOTA.

JENNIFER G. BRADY, P.E.


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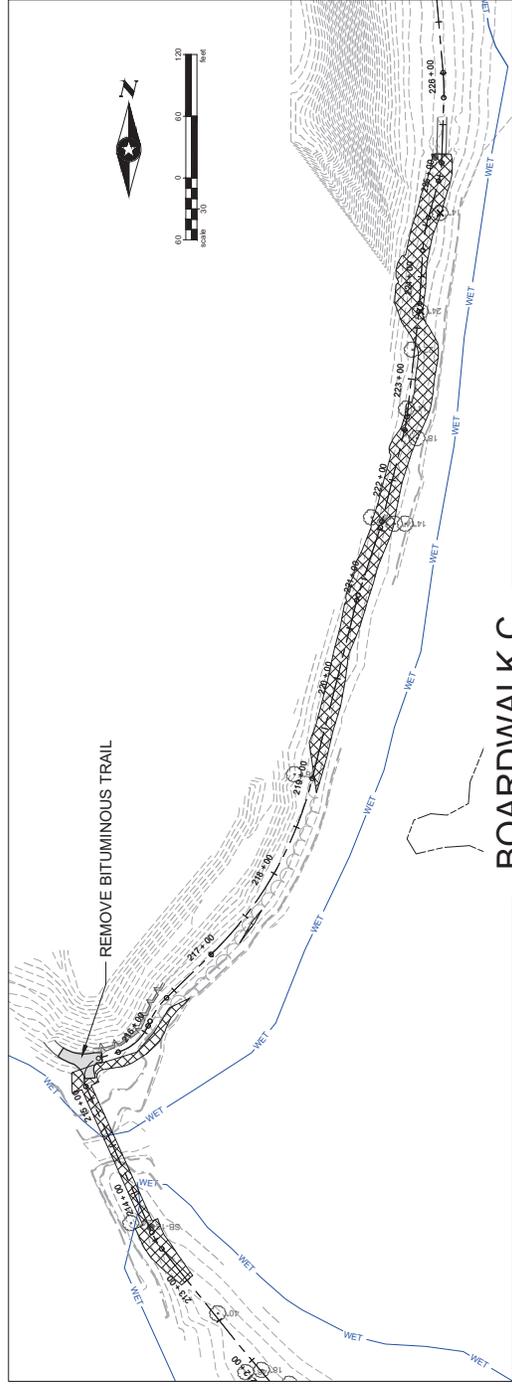
BOARDWALK A

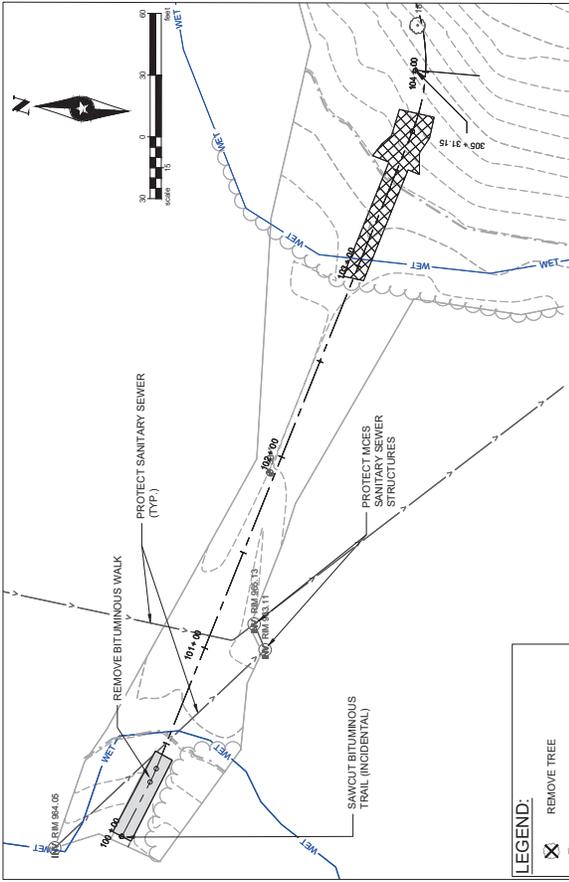LEGEND:

- REMOVE TREE
- PROTECT TREE
- CLEARING AND GRUBBING



BOARDWALK B

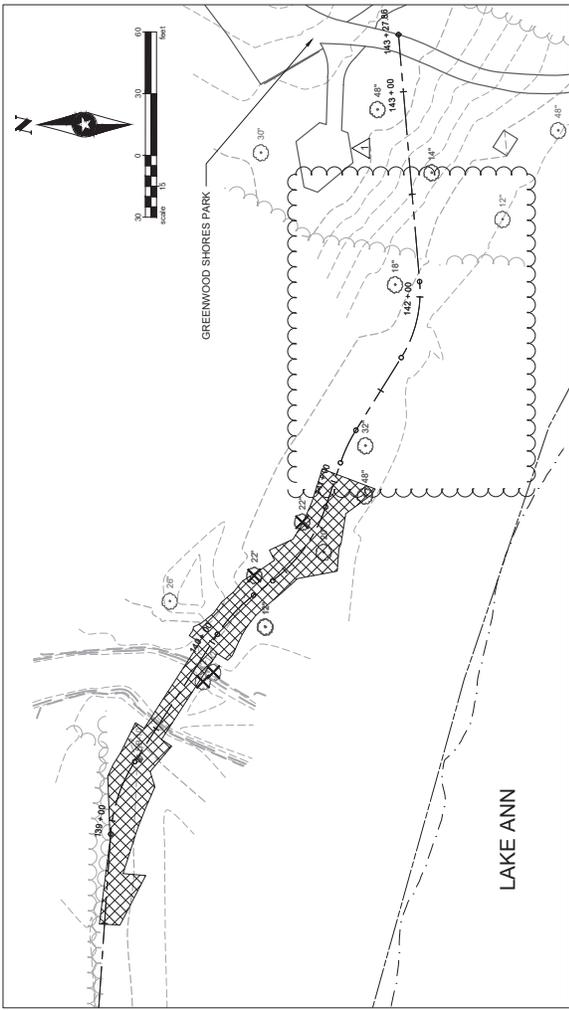

BOARDWALK C

NOTES:
 CENTER OF TREE SYMBOLS ARE LOCATED AT BASE OF TRUNK NEAREST THE PROPOSED TRAIL

SEH Project	H0517/684	Rev #	1	Date	01/15/24	Revision Issue Description	REVISED CONSTRUCTION ACCESS 2
Drawn By		Row #					
Designed By							
Checked By							

90% PRELIMINARY


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LAKE ANN PARK PRESERVE
 BOARDWALK IMPROVEMENT PROJECT


REMOVAL PLANS

CHANHASSEN, MN


6 of 7

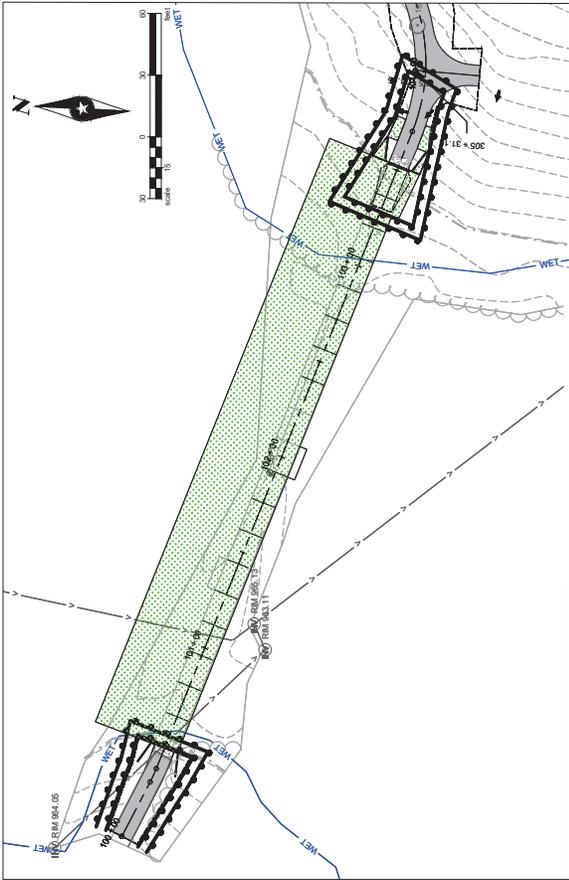

BOARDWALK A

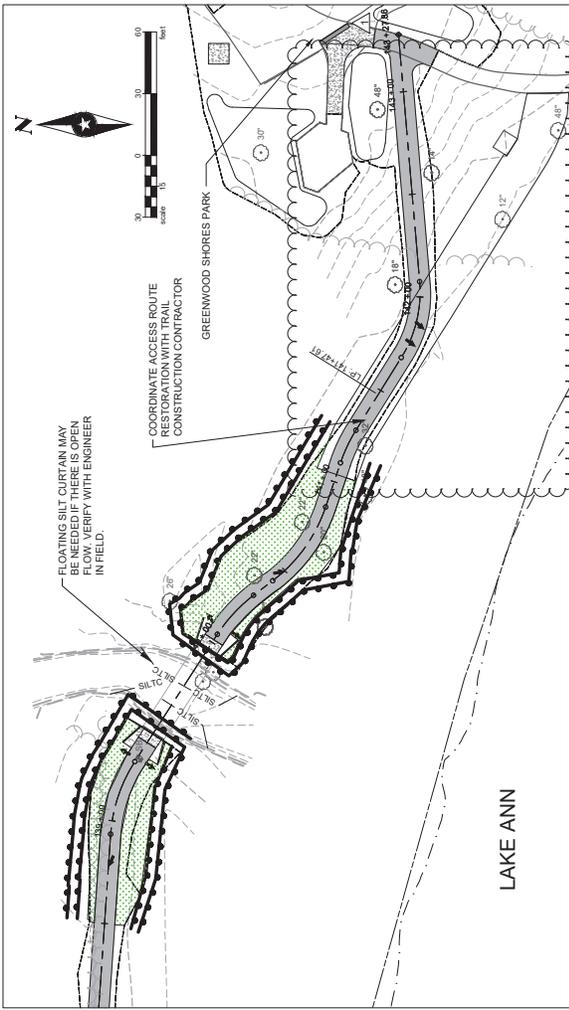

BOARDWALK B

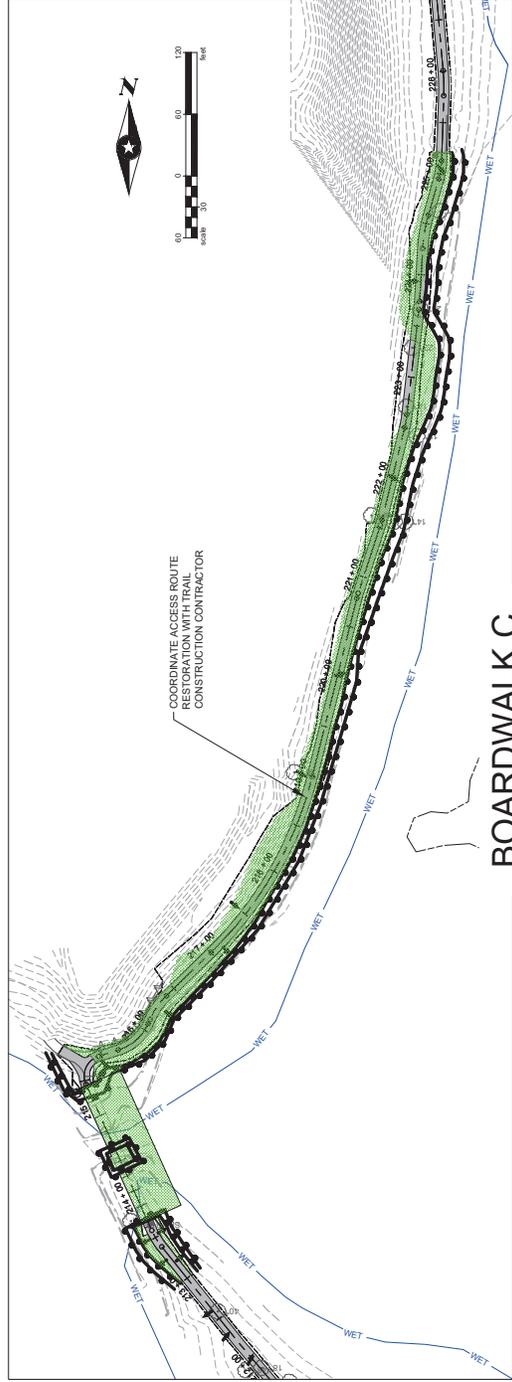

BOARDWALK C

LEGEND:

- DRAINAGE DIRECTION
- BIO ROLLS
- CONSTRUCTION LIMITS
- 6" TOP SOIL
- LANDFILL SEED MIXTURE 96-211
- HYDROSEED

NOTES:

- NATURAL TOPOGRAPHY AND SOIL CONDITIONS MUST BE PROTECTED, INCLUDING RETENTION ON SITE OF NATIVE TOPSOIL TO THE GREATEST EXTENT POSSIBLE.
- ADDITIONAL MEASURES, SUCH AS HYDRAULIC MULCHING AND OTHER PRACTICES AS SPECIFIED BY THE DISTRICT MUST BE USED ON SLOPES OF 3:1 (HV) OR STEEPER TO PROVIDE EROSION CONTROL.
- FINAL SITE STABILIZATION MEASURES MUST SPECIFY THAT AT LEAST SIX INCHES OF TOPSOIL OR ORGANIC MATTER BE SPREAD AND INCORPORATED INTO THE UNDERLYING SOIL DURING THE CONSTRUCTION PROCESS.
- DURING CONSTRUCTION, ALL WASTE SUCH AS DISCARDED BUILDING MATERIALS, CONCRETE TRUCK WASHOUT, CHEMICALS, LITTER AND SANITARY WASTE MUST BE PROPERLY MANAGED.
- ALL TEMPORARY EROSION AND SEDIMENT CONTROL BMPs MUST BE MAINTAINED UNTIL COMPLETED WORK IS ESTABLISHED AND VERIFIED BY THE DISTRICT.
- ALL TEMPORARY EROSION AND SEDIMENT CONTROL BMPs MUST BE REMOVED UPON FINAL STABILIZATION.
- ALL DISTURBED AREAS MUST BE STABILIZED WITHIN 7 CALENDAR DAYS AFTER COMPLETION OF CONSTRUCTION.
- TESTING PRESSURE OF LESS THAN 1,400 KILOPASCALS OR 200 POUNDS PER SQUARE INCH IN THE UPPER 12 INCHES OF THE SOIL PROFILE WHILE TAKING CARE TO PROTECT UTILITIES. TREE ROOTS MUST BE PROTECTED.
- ALL DISTURBED AREAS MUST BE STABILIZED WITHIN 7 CALENDAR DAYS AFTER LAND-DISTURBING WORK HAS TEMPORARILY OR PERMANENTLY CEASED ON A PROPERTY THAT IS NOT TO BE REPERMITTED.
- THE PERMITTEE MUST MAINTAIN INSPECT, MAINTAIN AND REPAIR ALL DISTURBED SURFACES AND ALL EROSION AND SEDIMENT CONTROL FACILITIES AND SOIL STABILIZATION MEASURES EVERY DAY WORK IS PERFORMED ON THE SITE AND AT LEAST WEEKLY UNTIL PERMITTEE WILL MAINTAIN A LOG OF ACTIVITIES UNDER THIS SECTION FOR INSPECTION BY THE DISTRICT ON REQUEST.
- ALL WORK MUST BE CONDUCTED SO AS TO MINIMIZE THE POTENTIAL TRANSFER OF AQUATIC INVASIVE SPECIES (E.G. ZEBRA MUSSELS, EURASIAN WATERMILFOLI) TO THE MAXIMUM EXTENT POSSIBLE.

Revision Issue	Description	Rev #	Date
1	INITIAL DESIGN	1	01/18/24
2	SUPPLEMENTAL WATERSHED DISTRICT INFO	2	01/18/24
3	REVISED CONSTRUCTION ACCESS 2	3	01/18/24

SEH PROJECT: H05177684
 DRAWN BY: [Name]
 DESIGNED BY: [Name]
 CHECKED BY: [Name]

90% PRELIMINARY

LAKE ANN PARK PRESERVE
 BOARDWALK IMPROVEMENT PROJECT
 CHANTHASSEN, MN

EROSION CONTROL AND
 TURF ESTABLISHMENT

7 of 7

DESIGN DATA

2020 AND CURRENT INTERMEDIATE LANE WIDTH, LRFD BRIDGE DESIGN SPECIFICATIONS AND 2009 LRFD GUIDE SPECIFICATIONS FOR THE DESIGN OF PEDESTRIAN BRIDGES.
 LOAD AND RESISTANCE FACTOR DESIGN METHOD.
 DESIGN LOADING:
 PEDESTRIAN LOADING 90 PSF OR BOARDWALK A & C 20,000 POUND BOARDWALK B 72,000 POUND VEHICLE LIVE LOAD (HS20 TRUCK)

DESIGN SPEED 20 MPH.
 APPROX. DECK AREA: BRIDGE A 3,792 SQ. FT. BRIDGE B 1,734 SQ. FT. BRIDGE C 1,734 SQ. FT.

MATERIALS:
 STRUCTURAL STEEL SHALL BE A500T 3310 CONFORMING TO ASTM A709 GRD 50, HOT-DIP GALVANIZED IN ACCORDANCE WITH MNDOT 3394.
 TIMBER MATERIALS AND TREATMENT SHALL BE:

ITEM	DESCRIPTION
STRINGERS,	DOUGLAS FIR, SELECT STR, ROUGH SAWN.
DIAPHRAGMS,	DOUGLAS FIR, SELECT STR, ROUGH SAWN.
PILE CAP	COPPER AZOLE (CACC), COPPER NAPHTHENATE (CUNAP), AMMONIACAL COPPER ZINC ARSENATE (ACZA), ACCORDING TO MNDOT 3394 CATEGORY - U/C42(GROUND CONTACT, CRITICAL STRUCTURAL COMPONENTS). DOUGLAS FIR SHALL BE NOISED.

DOUGLAS FIR NO. 1 & BETTER, S4S TREATMENT SAME AS ABOVE
 SOUTHERN YELLOW PINE OR DOUGLAS FIR NO. 2 OR FR-880 FSI TREATMENT SAME AS ABOVE BUT WITH RETENTION USE CATEGORY - (NO) (SUPERIOR ABOVE GROUND)
 SOLID COMPOSITE (IE TREX) OR TROPICAL HARDWOOD (IE IPE OR OUMBU)

DECK PLANKING & ABUTMENT BACKING PLANK TREATMENT SAME AS ABOVE
 RAIL POST, RAILS & POST SPACER BLOCK SOUTHERN YELLOW PINE OR DOUGLAS FIR NO. 2 OR FR-880 FSI TREATMENT SAME AS ABOVE BUT WITH RETENTION USE CATEGORY - (NO) (SUPERIOR ABOVE GROUND)
 TOP RAIL CAP SOLID COMPOSITE (IE TREX) OR TROPICAL HARDWOOD (IE IPE OR OUMBU)

CONSTRUCTION NOTES
 THE 2020 EDITION OF THE MINNESOTA DEPARTMENT OF TRANSPORTATION STANDARD SPECIFICATIONS FOR CONSTRUCTION.

SHEET INDEX

NO.	DESCRIPTION
B1	BOARDWALK A PLAN AND PROFILE
B2	BOARDWALK B & C PLAN AND PROFILE
B3	BOARDWALK LAYOUT & QUANTITIES
B4	GENERAL DETAILS & TYPICAL SECTIONS
B5	ABUTMENT & SUBSTRUCTURE DETAILS
B6	APPROACH & RAILING DETAILS
B7	OVERLOOK DETAILS

BRIDGES NOS. A, B & C.
 LOCATED IN THE CITY OF CHANHASSEN BETWEEN LAKE ANN AND LAKE LUCY, TIMBER BEAMS, 16' SPANS, 12' WIDE TRAIL, PEDESTRIAN RAILING, 0'00"00" SKEW, IDENTIFICATION NOS. 301 & 301

GENERAL PLAN AND ELEVATION
 SEC. 10 R 23 W COUNTY: CARVER CITY: CHANHASSEN T 116 N

BOARDWALK A PLAN AND PROFILE

LAKE ANN PARK PRESERVE BOARDWALK IMPROVEMENT PROJECT
 CHANHASSEN, MN

90% PRELIMINARY
 DATE: 12-28-2023
 LICENSE NO: 17290

Revision Issue Description
 Revision Issue Description
 Revision Issue Description

Row #
 Date
 Date


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 DESIGNED BY: [Redacted]
 CHECKED BY: [Redacted]

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 HEREBY CERTIFY THAT THIS PLAN WAS PREPARED BY ME OR UNDER MY DIRECT SUPERVISION AND I AM A LICENSED PROFESSIONAL ENGINEER UNDER THE BOARD OF ENGINEERS AND SURVEYORS OF THE STATE OF MINNESOTA.
 JEFF A. JAROSLOVSKY
 DATE: 12-28-2023
 LICENSE NO: 17290



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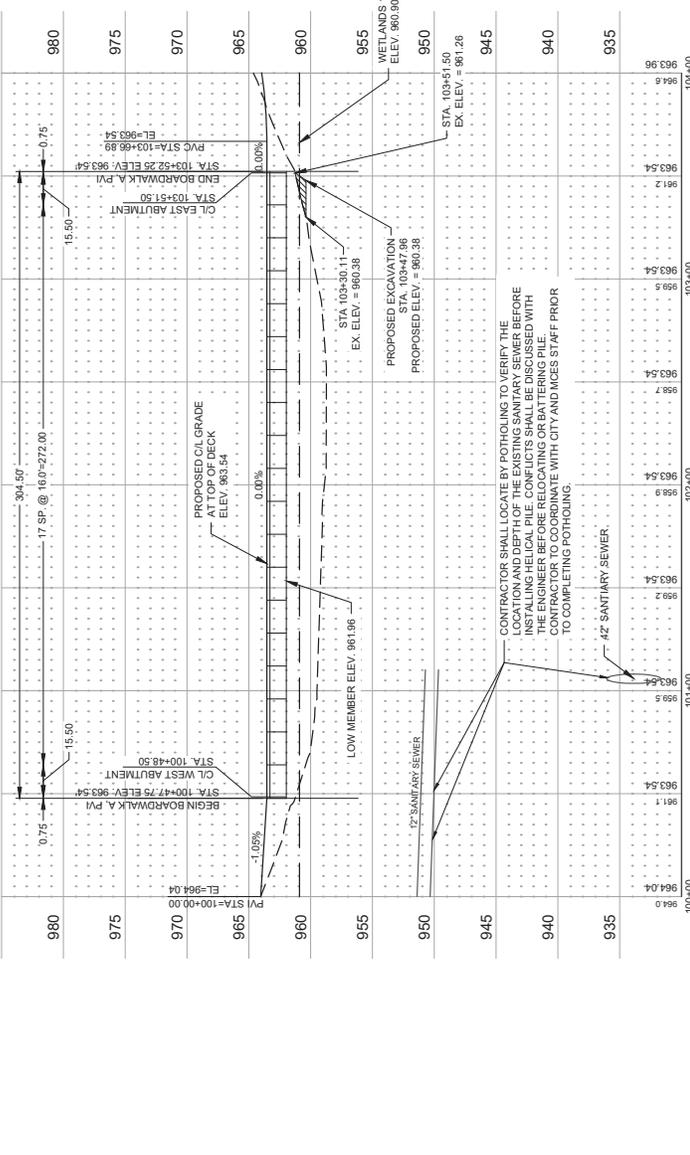
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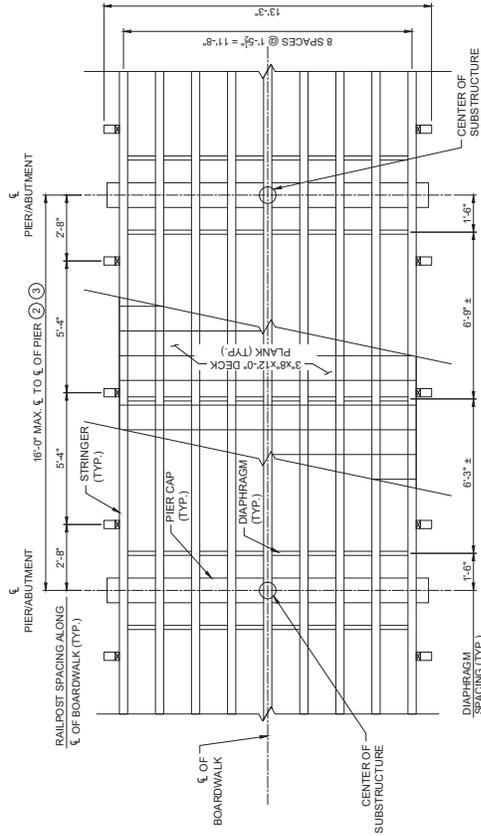


BOARDWALK A

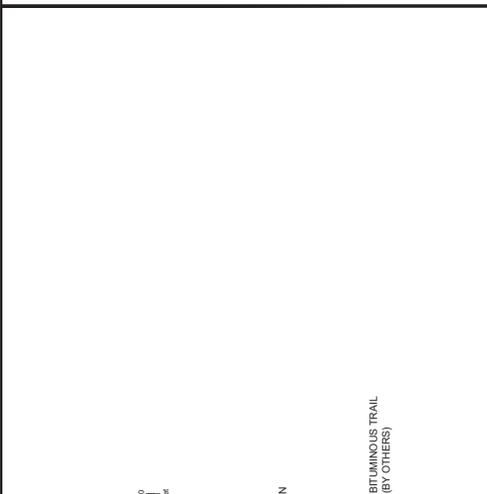


BOARDWALK A



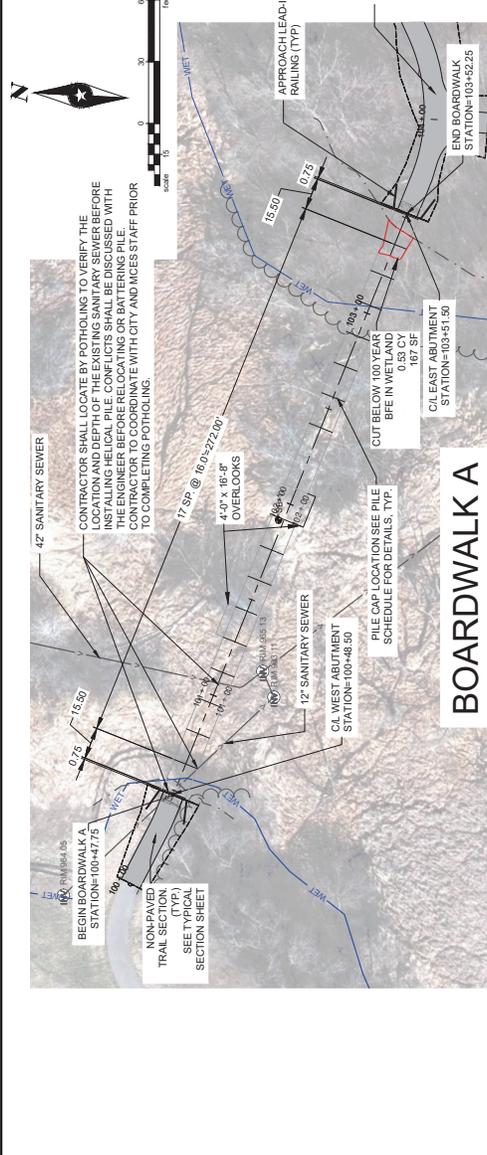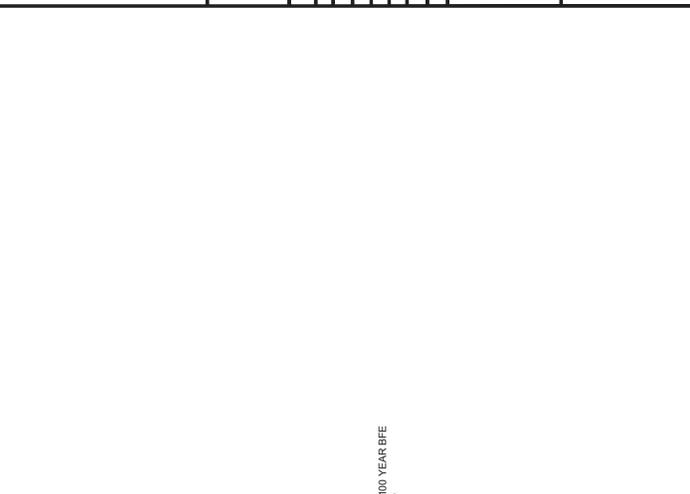


FRAMING PLAN

NOTE: TIMBER STRINGER SPACING SHOWN

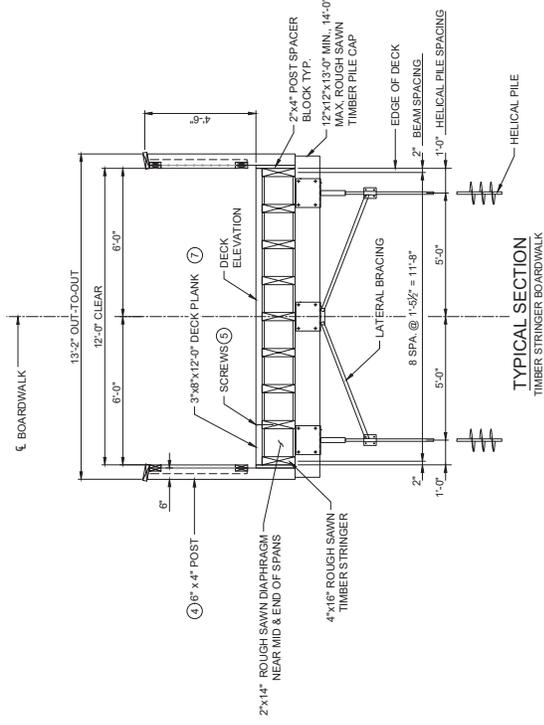


TYPICAL SECTION
TIMBER STRINGER BOARDWALK

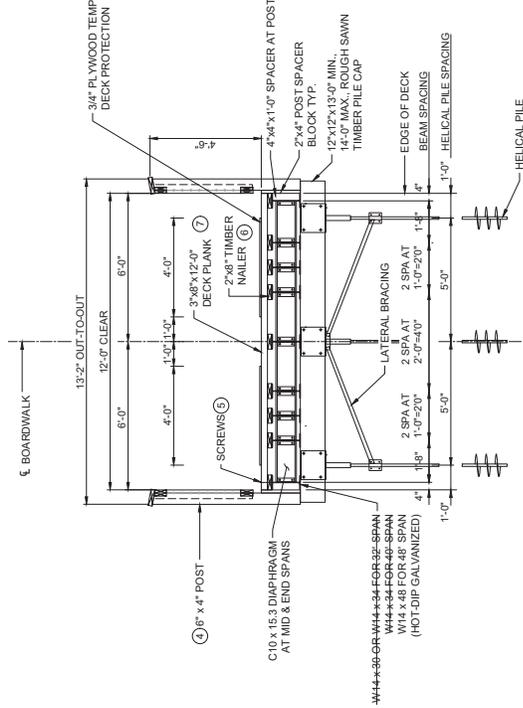

TYPICAL SECTION
STEEL STRINGER BOARDWALK

NOTE: 3 PILES AT STEEL SPANS CREEK CROSSING

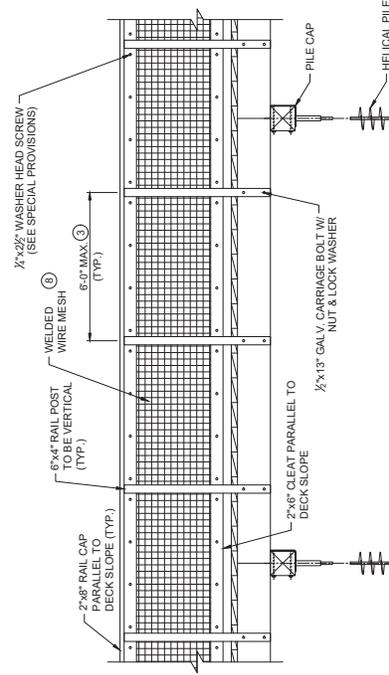

ELEVATION


- NOTES:
1. WHEN BOARDWALK IS ON CURVES ALIGNMENT STRINGSERS & RAILING WILL BE CHORDS BETWEEN PIER SUBSTRUCTURE OR RAIL POSTS. LAYOUT DECK PLANK WITH NO EDGE GAP TO 1/2" MAX GAP ON CURVES. USE NO GAP TO 1/2" GAP ON TANGENT ALIGNMENT. PLANK MAY NEED TO BE TAPER CUT TO MAINTAIN GAP.
 2. MEASURED ALONG ξ OF TRAIL CHORD AS SHOWN.
 3. RAILING DIMENSIONS TO BE ADJUSTED AS NECESSARY DUE TO BRIDGE CURVES.
 4. TOP OF POST SLOPED (1" HEIGHT DIFFERENCE OUTSIDE FACE TO INSIDE FACE). POSTS TO BE VERTICAL.
 5. SCREWS - 2 PER PLANK AT EACH STRINGER DRIVE TOP OF SCREW HEAD FLUSH WITH TOP OF DECK. SEE SPECIAL PROVISIONS FOR SCREW TYPE.
 6. ATTACH NAILER TO BEAM WITH 3/8" Ø HOT-DIP GALVANIZED NAIL. NAILER SHALL BE SPACED ALONG WEB BUT BEAT ONE INCH FROM EDGE OF BEAM FLANGE. COUNTER BORE HEAD FLUSH WITH TOP OF NAILER.
 7. PLACE DECK PLANK WITH GROWTH RINGS CONVEY SIDE UP. NAILER TO BE PLACED FROM WHICH PLANK IS CUT WOULD BE BELOW DECK.
 8. WELDED WIRE MESH MAY REQUIRE RACKING OR CUTTING ON SEGMENTS WHERE THE DECK AND RAILING SLOPE.

Revision Issue	Date	Rev #	Row #
DESCRIPTION			

90% PRELIMINARY




HEREBY CERTIFY THAT THIS PLAN WAS PREPARED BY ME OR UNDER MY DIRECT SUPERVISION AND THAT I AM A LICENSED PROFESSIONAL ENGINEER UNDER THE PROVISIONS OF THE ENGINEERING ACT OF MINNESOTA.
JEFF A. JARROLD, P.E.
DATE: 12-28-2023 LICENSE NO: 17290

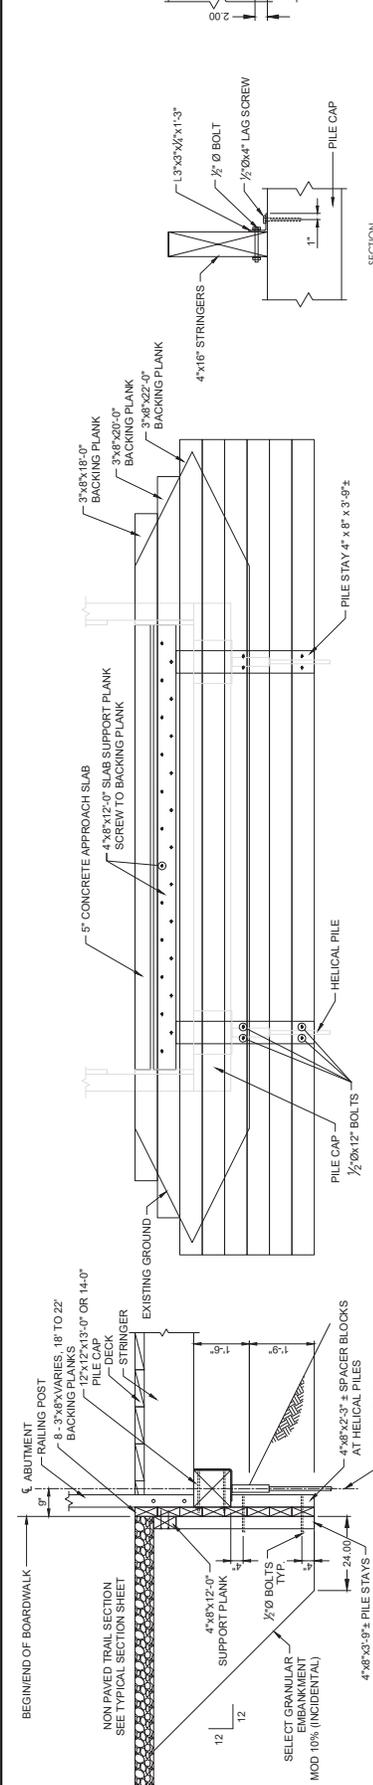

ABUTMENT SECTION

ABUTMENT ELEVATION
NOTE: BACKSIDE SHOWN


PIER DETAIL

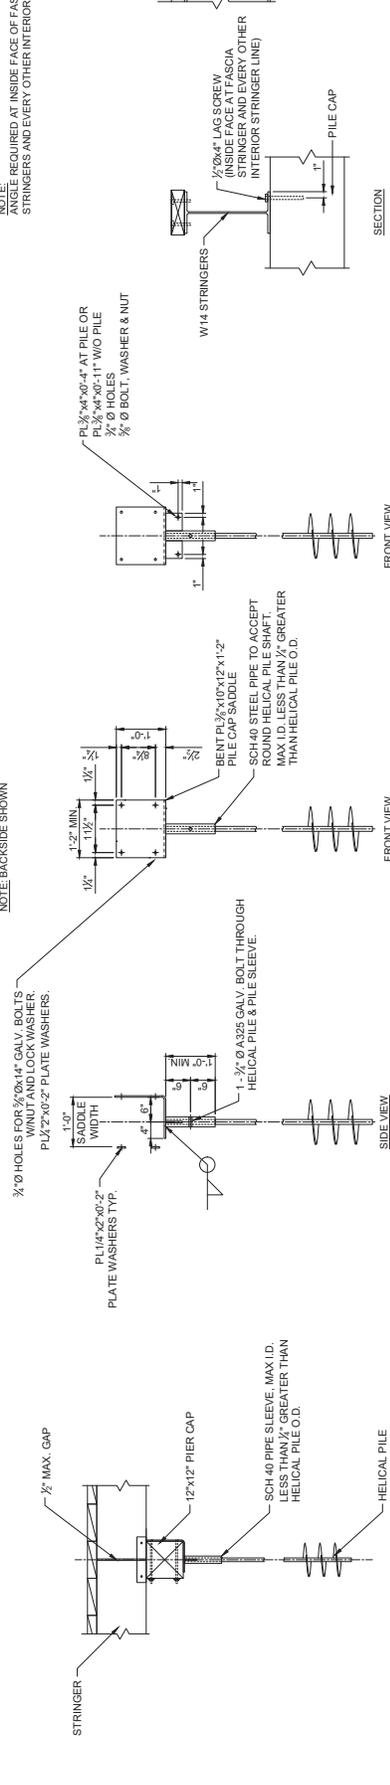

SUPPORT BRACKET DETAIL
NOTE: HOT DIPPED GALVANIZED PER ASTM A-153.

CLAMP CONNECTION DETAIL
BRACED TO HELICAL PILE

LATERAL BRACING DETAIL
① CAREFULLY POSITION PILE SPLICES AND BRACKETS TO OBTAIN EQUAL SLOPES ON LATERAL BRACES.

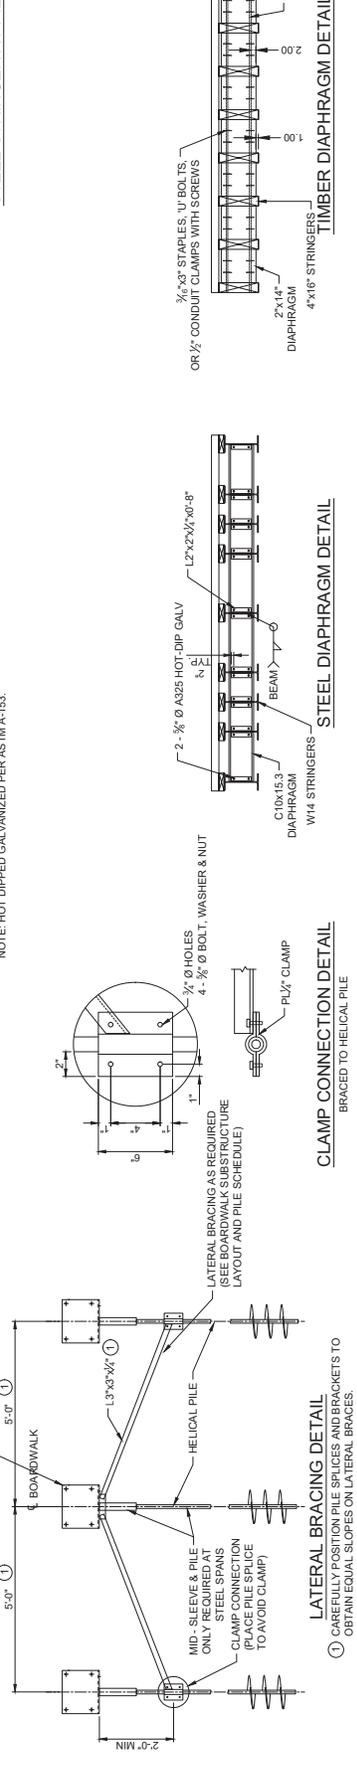

STEEL STRINGER AT PILE CAP

STEEL DIAPHRAGM DETAIL

TIMBER DIAPHRAGM DETAIL

SEH Project: H0517/684
 Drawn By: [Blank]
 Designed By: [Blank]
 Checked By: [Blank]


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 2 90% PRELIMINARY
 3 100% PRELIMINARY

Rev # Date
 1 12/20/2023
 2 12/20/2023
 3 12/20/2023

SEH
 JEFF A. ZARRO, P.E.
 LICENSE NO. 12780
 DATE 12-20-2023

LAKE ANN PARK PRESERVE
 BOARDWALK IMPROVEMENT PROJECT
 CHANTHASSEN, MN

ABUTMENT & SUBSTRUCTURE DETAILS
 B5 of B7








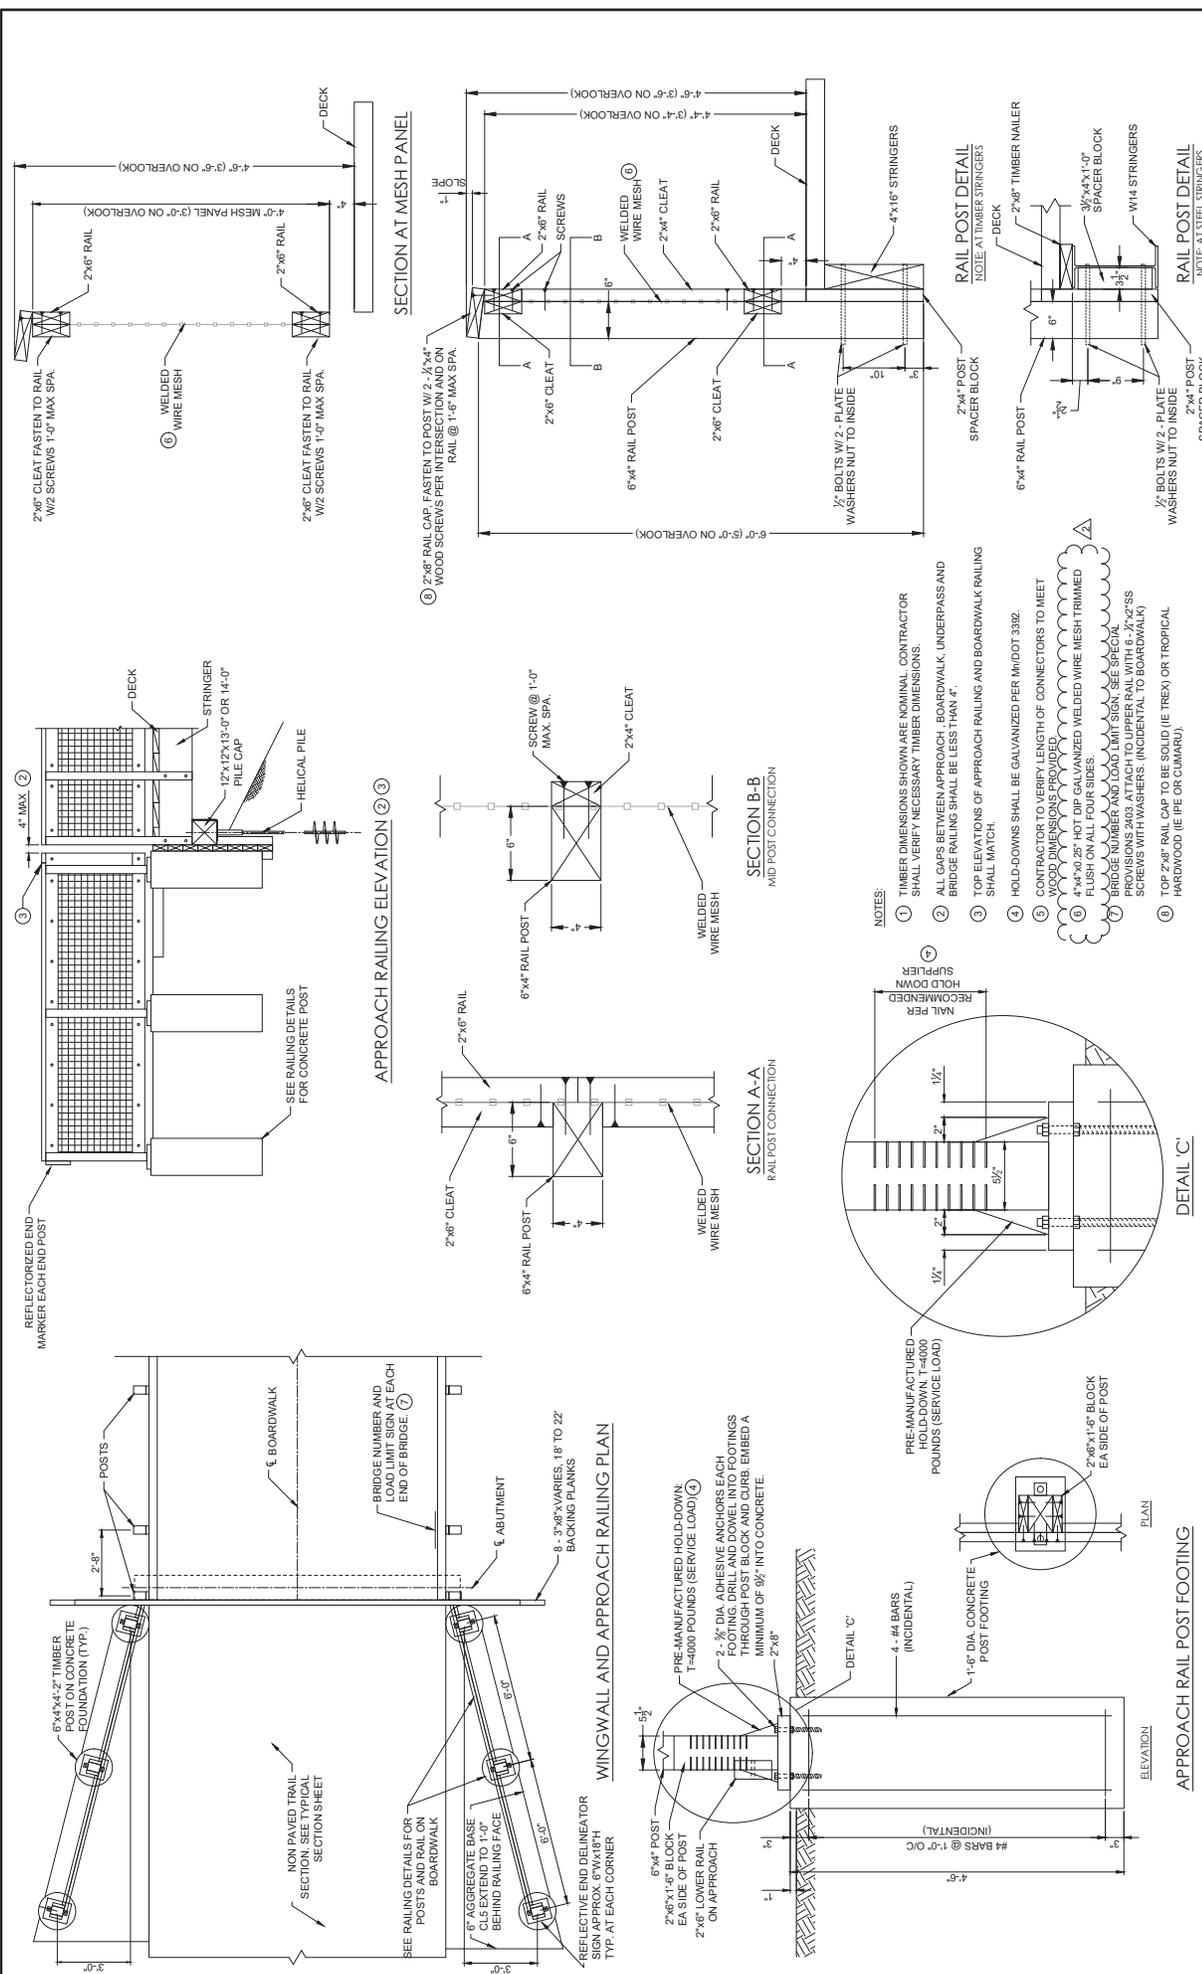


Revision Issue	Revision Description	Date	Rev #
1	WIRE MESH REVISION	01/09/24	1
2			2

SEH Project	H05171684
Drawn By	
Designed By	
Checked By	

Revision Issue	Description	Date	Rev #
1	90% PRELIMINARY	01/09/24	1
2			2

Revision Issue: Description: Date: Rev #
 90% PRELIMINARY
 01/09/24
 WIRE MESH REVISION
 2

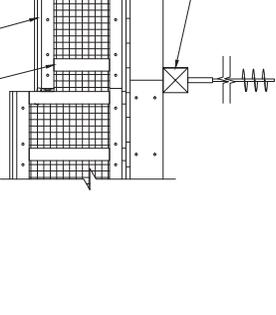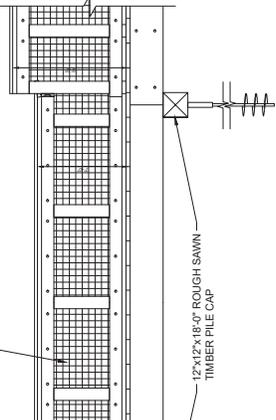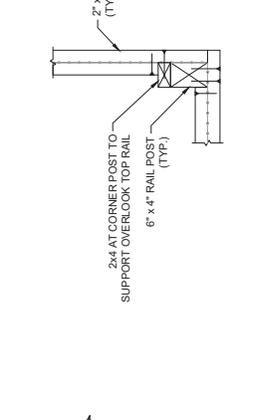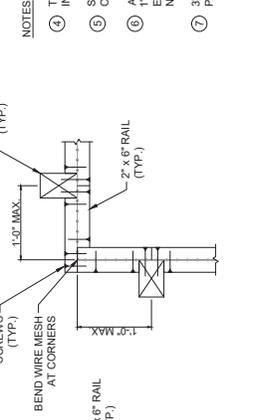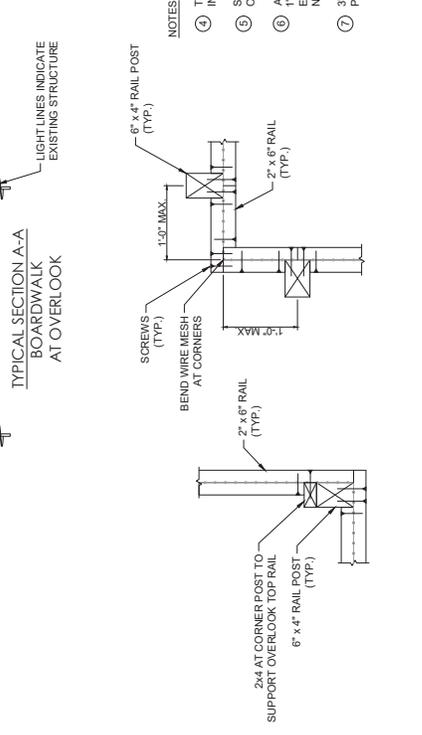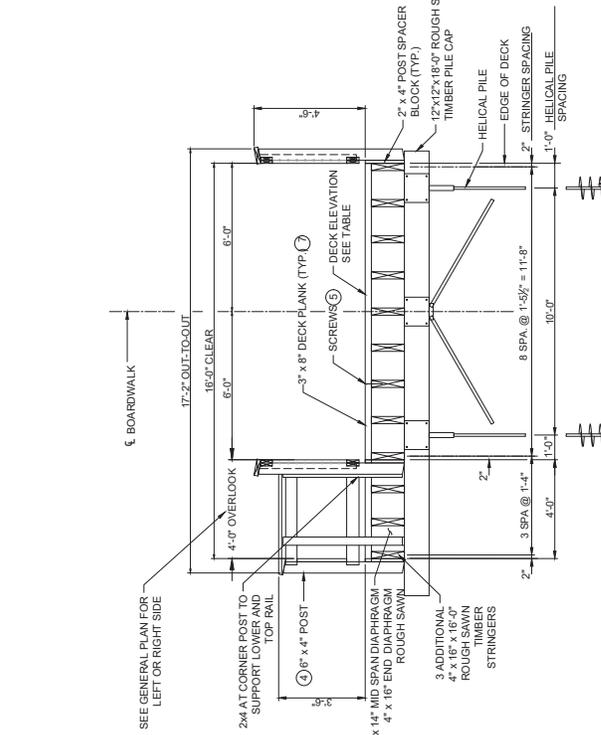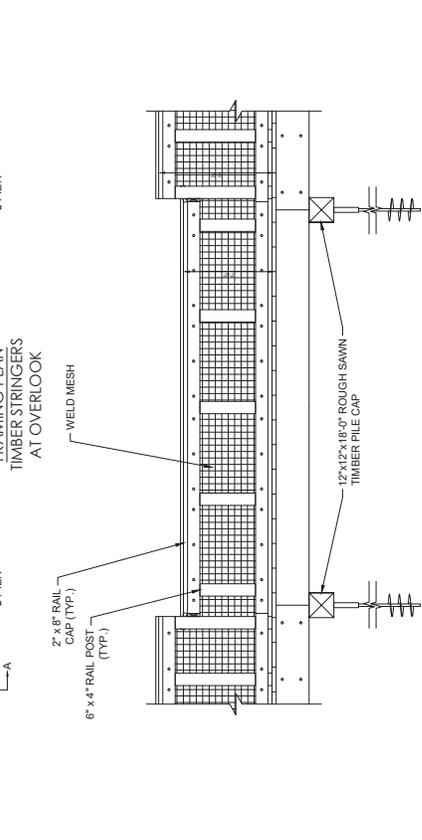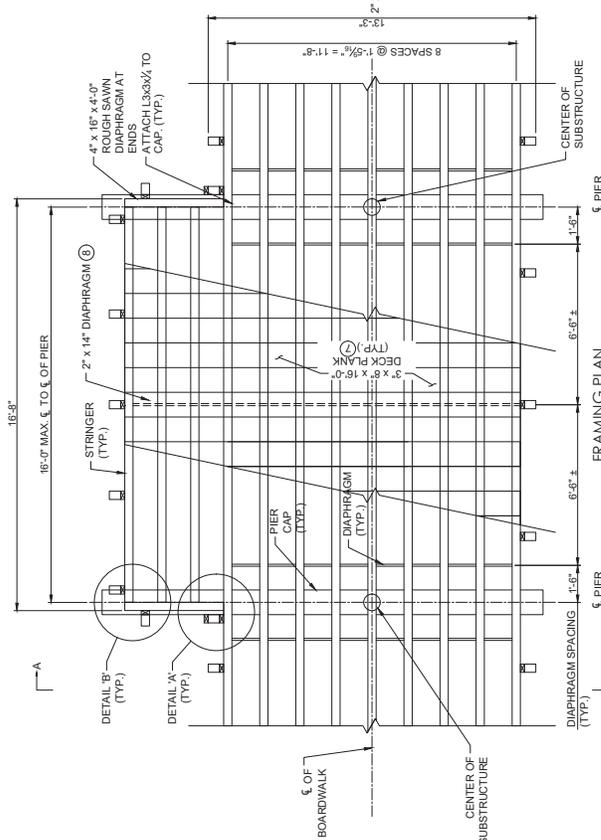

NOTES:
 ④ TOP OF POST SLOPED (1" HEIGHT DIFFERENCE OUTSIDE FACE TO INSIDE FACE)
 ⑤ SCREWS - 2 PER PLANK AT EACH STRINGER, DRIVE FLUSH WITH TOP OF DECK. SEE SPECIAL PROVISIONS FOR SCREW TYPE.
 ⑥ ATTACH NAILER TO BEAM WITH 3/8" Ø HOT-DIP GALVANIZED BOLTS AT 1'-0" SPA. ALTERNATING SIDES ALONG WEB OF BEAM. ONE INCH FROM CENTER OF BEAM FLANGE, COUNTERBORE HEAD FLUSH WITH TOP OF NAILER.
 ⑦ 3" X 8" X 16'-0" DECK PLANKING. IF DECK PLANK BOARDS ARE CLIPPED, PLACE CONVEX SIDE UP

Permit Number
2023-2932

Public Waters Work Permit

Expiration Date: 12/31/2024

Pursuant to Minnesota Statutes, Chapter 103G, and on the basis of statements and information contained in the permit application, letters, maps, and plans submitted by the applicant and other supporting data, all of which are made part hereof by reference, **PERMISSION IS HEREBY GRANTED** to the applicant to perform actions as authorized below.

Project Name: Lake Ann Preserve Boardwalk	County: Carver	Watershed: Lower Minnesota River	Resource: Lake: Ann (10001200); Lake: Lucy (10000700)
Purpose of Permit: Boardwalk		Authorized Action: Install 48-ft long steel beam span pedestrian bridge over the outlet channel of Lake Lucy. All work shall be done in accordance with the plans and supporting materials on file.	
Permittee: CITY OF CHANHASSEN CONTACT: RUEGEMER, JERRY, (952) 227-1121 7700 MARKET BOULEVARD PO BOX 147 CHANHASSEN, MN 55317 (952) 227-1100		Authorized Agent: SEH INC - ST. PAUL CONTACT: BEDUHN, REBECCA, (651) 490-2146 3535 VADNAIS CENTER DRIVE ST. PAUL, MN 55110 (651) 490-2000	
Property Description (land owned or leased or where work will be conducted): UTM zone 15N, 455997m east, 4969202m north, NWNW of Section 11, T116N, R23W			
Issued Date: 11/09/2023	Effective Date: 11/09/2023	Expiration Date: 12/31/2024	
Authorized Issuer: Taylor Huinker	Title: Area Hydrologist	Email Address: taylor.huinker@state.mn.us	Phone Number: 651-259-5790

This permit is granted **subject to** the following **CONDITIONS**:

APPLICABLE FEDERAL, STATE, OR LOCAL REGULATIONS: The permittee is not released from any rules, regulations, requirements, or standards of any applicable federal, state, or local agencies; including, but not limited to, the U.S. Army Corps of Engineers, Board of Water and Soil Resources, MN Pollution Control Agency, watershed districts, water management organizations, county, city and township zoning.

NOT ASSIGNABLE: This permit is not assignable by the permittee except with the written consent of the Commissioner of Natural Resources.

NO CHANGES: The permittee shall make no changes, without written permission or amendment previously obtained from the Commissioner of Natural Resources, in the dimensions, capacity or location of any items of work authorized hereunder.

SITE ACCESS: The permittee shall grant access to the site at all reasonable times during and after construction to authorized representatives of the Commissioner of Natural Resources for inspection of the work authorized hereunder.

TERMINATION: This permit may be terminated by the Commissioner of Natural Resources at any time deemed necessary for the conservation of water resources of the state, or in the interest of public health and welfare, or for violation of any of the conditions or applicable laws, unless otherwise provided in the permit.

CONDITIONS (Continued from previous page)

COMPLETION DATE: Construction work authorized under this permit shall be completed on or before the date specified above. The permittee may request an extension of the time to complete the project by submitting a written request, stating the reason thereof, to the Commissioner of Natural Resources.

WRITTEN CONSENT: In all cases where the permittee by performing the work authorized by this permit shall involve the taking, using, or damaging of any property rights or interests of any other person or persons, or of any publicly owned lands or improvements thereon or interests therein, the permittee, before proceeding, shall obtain the written consent of all persons, agencies, or authorities concerned, and shall acquire all property, rights, and interests needed for the work.

PERMISSIVE ONLY / NO LIABILITY: This permit is permissive only. No liability shall be imposed by the State of Minnesota or any of its officers, agents or employees, officially or personally, on account of the granting hereof or on account of any damage to any person or property resulting from any act or omission of the permittee or any of its agents, employees, or contractors. This permit shall not be construed as estopping or limiting any legal claims or right of action of any person other than the state against the permittee, its agents, employees, or contractors, for any damage or injury resulting from any such act or omission, or as estopping or limiting any legal claim or right of action of the state against the permittee, its agents, employees, or contractors for violation of or failure to comply with the permit or applicable conditions.

EXTENSION OF PUBLIC WATERS: Any extension of the surface of public waters from work authorized by this permit shall become public waters and left open and unobstructed for use by the public.

WETLAND CONSERVATION ACT: Where the work authorized by this permit involves the draining or filling of wetlands not subject to DNR regulations, the permittee shall not initiate any work under this permit until the permittee has obtained official approval from the responsible local government unit as required by the Minnesota Wetland Conservation Act.

CONTRACTOR RESPONSIBILITY: The permittee shall ensure the contractor has received and thoroughly understands all conditions of this permit. Contractors must obtain a signed statement from the property owner stating that permits required for work have been obtained or that a permit is not required, and mail a copy of the statement to the regional DNR Enforcement office where the proposed work is located. The Landowner Statement and Contractor Responsibility Form can be found at: https://bwsr.state.mn.us/sites/default/files/2019-01/Wetland_WCA_Contractor_Responsibility_Form.doc

INVASIVE SPECIES - EQUIPMENT DECONTAMINATION: All equipment intended for use at a project site must be free of prohibited invasive species and aquatic plants prior to being transported into or within the state and placed into state waters. All equipment used in designated infested waters, shall be inspected by the Permittee or their authorized agent and adequately decontaminated prior to being transported from the worksite. The DNR is available to train inspectors and/or assist in these inspections. For more information refer to the "Best Practices for Preventing the Spread of Aquatic Invasive Species" at http://files.dnr.state.mn.us/publications/ewr/invasives/ais/best_practices_for_prevention_ais.pdf. Contact your regional Invasive Species Specialist for assistance at www.mndnr.gov/invasives/contacts.html. A list of designated infested waters is available at www.mndnr.gov/invasives/ais/infested.html. A list of prohibited invasive species is available at www.mndnr.gov/invasives/laws.html#prohibited.

EROSION AND SEDIMENT CONTROL: In all cases, methods that have been determined to be the most effective and practical means of preventing or reducing sediment from leaving the worksite shall be installed in areas that slope to the water and on worksite areas that have the potential for direct discharge due to pumping or draining of areas from within the worksite (e.g., coffer dams, temporary ponds, stormwater inlets). These methods, such as mulches, erosion control blankets, temporary coverings, silt fence, silt curtains or barriers, vegetation preservation, redundant methods, isolation of flow, or other engineering practices, shall be installed concurrently or within 24 hours after the start of the project, and will be maintained for the duration of the project in order to prevent sediment from leaving the worksite. DNR requirements may be waived in writing by the authorized DNR staff based on site conditions, expected weather conditions, or project completion timelines.

FISHERY PROTECTION - EXCLUSION DATES: No activity affecting the bed of the protected water may be conducted between April 1 and June 30, to minimize impacts on fish spawning and migration. If work during this time is essential, it shall be done only upon written approval of the Area Fisheries Manager. See contact list at: http://files.dnr.state.mn.us/fisheries/management/dnr_fisheries_managers.pdf. Should work begin elsewhere in the project area within these dates, all exposed soils that are within 200 feet of Public Waters and drain to those waters must complete erosion control measures within 24 hours of its disturbance to prevent sediment from entering Public Waters.

MAINTENANCE: Maintenance of this project to originally authorized conditions may be authorized by amendment to this permit.

CONDITIONS (Continued from previous page)

WILDLIFE FRIENDLY EROSION CONTROL MATERIALS: Due to entanglement issues with small animals, use of erosion control blanket shall be limited to 'bio-netting' or 'natural-netting' types, and specifically not products containing plastic mesh netting or other plastic components. Also be aware that hydro-mulch products may contain small synthetic (plastic) fibers to aid in its matrix strength. These loose fibers could re-suspend and make their way into Public Waters. As such, mulch products containing plastic fiber additives should not be used in areas that drain to Public Waters. See this website for additional resources:

<https://www.dot.state.mn.us/environment/erosion/rolled-erosion-prevention-products.html>

cc: John Gleason, EWR District Manager
Arnaud Kpachavi, Conservation Officers, Mound
Alyssa Core, BWSR Wetland Specialists, Carver
Melissa Collins, DNR Regional Environmental Assessment Ecologist, Region 3
Tim Pharis, DNR Wildlife, Vermillion River Complex
Daryl Ellison, DNR Fisheries, West Metro Area
Paul Moline, County, Carver
Jason Mielke, County, Carver
Kristen Larson, County, Carver
Terry Jeffery, Watershed District, RILEY-PURGATORY-BLUFF CREEK WD
Corps of Engineers, Corps of Engineers, Carver
Mike Wanous, SWCD, Carver SWCD
Charles Howley, City, Chanhassen
Erik Henricksen, City, Chanhassen

Amended

Public Waters Work General Permit

Expiration Date: 05/01/2025
General Permit Number
2015-1192

Pursuant to Minnesota Statutes, Chapter 103G, and on the basis of statements and information contained in the permit application, letters, maps, and plans submitted by the applicant and other supporting data, all of which are made part hereof by reference, **PERMISSION IS HEREBY GRANTED** to the applicant to perform actions as authorized below. This permit supersedes the original permit and all previous amendments.

Project Name: Riley-Purgatory-Bluff Creek Watershed District General Permit	County: Hennepin and Carver	Watershed: Lower Minnesota River - Shakopee	Resource: All Public Waters within Riley-Purgatory-Bluff Creek Watershed
Purpose of Permit: Sediment Removal, Sand Blanket w/o Excavation, Sand Blanket w/ Excavation, Riprap (Natural Rock), Retaining Wall, Erosion Control/Stabilization Fill & Grading, Culvert Construction/Modification/Replacement, Bridge Construction/Modification/Replacement, Bioengineering		Authorized Action: Place natural rock riprap; shape banks/shorelines for placement of riprap or bioengineering; install beach sand blankets; construct retaining walls, bridges and culverts; remove structures; remove sediment; all in accordance with the Conditions of this permit. For actions addressed by this general permit, no separate GP Authorization is needed from the DNR.	
Permittee: Riparian Property Owners within Riley-Purgatory-Bluff Creek Watershed District		Authorized Agent: N/A	
Property Description (land owned or leased or where work will be conducted):			
Issued Date: 06/15/2020	Effective Date: 05/01/2020	Expiration Date: 05/01/2025	
Authorized Issuer: Tom Hovey	Title: Water Regulations Unit Supervisor	Email Address: tom.hovey@state.mn.us	Phone Number: 651-259-5654

This permit is granted **subject to** the following **CONDITIONS**:

APPLICABLE FEDERAL, STATE, OR LOCAL REGULATIONS: The permittee is not released from any rules, regulations, requirements, or standards of any applicable federal, state, or local agencies; including, but not limited to, the U.S. Army Corps of Engineers, Board of Water and Soil Resources, MN Pollution Control Agency, watershed districts, water management organizations, county, city and township zoning.

NOT ASSIGNABLE: This permit is not assignable by the permittee except with the written consent of the Commissioner of Natural Resources.

NO CHANGES: The permittee shall make no changes, without written permission or amendment previously obtained from the Commissioner of Natural Resources, in the dimensions, capacity or location of any items of work authorized hereunder.

SITE ACCESS: The permittee shall grant access to the site at all reasonable times during and after construction to authorized representatives of the Commissioner of Natural Resources for inspection of the work authorized hereunder.

TERMINATION: This permit may be terminated by the Commissioner of Natural Resources at any time deemed

GENERAL PERMIT CONDITIONS *(Continued from previous page)*

necessary for the conservation of water resources of the state, or in the interest of public health and welfare, or for violation of any of the conditions or applicable laws, unless otherwise provided in the permit.

COMPLETION DATE: Construction work authorized under this permit shall be completed on or before the date specified above. The permittee may request an extension of the time to complete the project by submitting a written request, stating the reason thereof, to the Commissioner of Natural Resources.

WRITTEN CONSENT: In all cases where the permittee by performing the work authorized by this permit shall involve the taking, using, or damaging of any property rights or interests of any other person or persons, or of any publicly owned lands or improvements thereon or interests therein, the permittee, before proceeding, shall obtain the written consent of all persons, agencies, or authorities concerned, and shall acquire all property, rights, and interests needed for the work.

PERMISSIVE ONLY / NO LIABILITY: This permit is permissive only. No liability shall be imposed by the State of Minnesota or any of its officers, agents or employees, officially or personally, on account of the granting hereof or on account of any damage to any person or property resulting from any act or omission of the permittee or any of its agents, employees, or contractors. This permit shall not be construed as estopping or limiting any legal claims or right of action of any person other than the state against the permittee, its agents, employees, or contractors, for any damage or injury resulting from any such act or omission, or as estopping or limiting any legal claim or right of action of the state against the permittee, its agents, employees, or contractors for violation of or failure to comply with the permit or applicable conditions.

EXTENSION OF PUBLIC WATERS: Any extension of the surface of public waters from work authorized by this permit shall become public waters and left open and unobstructed for use by the public.

GP AUTHORIZATION - APPLY USING MPARS: The permittee shall apply for prior authorization for all projects to be constructed under this General Permit using the MNDNR Permitting and Reporting System (MPARS) at www.mndnr.gov/mpars/signin . Users will need to create an account the first time they access the system. Once created, click on the link for 'Apply for a New Permit/Authorization' under the Actions box and complete the application questions.

WETLAND CONSERVATION ACT: Where the work authorized by this permit involves the draining or filling of wetlands not subject to DNR regulations, the permittee shall not initiate any work under this permit until the permittee has obtained official approval from the responsible local government unit as required by the Minnesota Wetland Conservation Act.

INVASIVE SPECIES - EQUIPMENT DECONTAMINATION: All equipment intended for use at a project site must be free of prohibited invasive species and aquatic plants prior to being transported into or within the state and placed into state waters. All equipment used in designated infested waters, shall be inspected by the Permittee or their authorized agent and adequately decontaminated prior to being transported from the worksite. The DNR is available to train inspectors and/or assist in these inspections. For more information refer to the "Best Practices for Preventing the Spread of Aquatic Invasive Species" at http://files.dnr.state.mn.us/publications/ewr/invasives/ais/best_practices_for_prevention_ais.pdf. Contact your regional Invasive Species Specialist for assistance at www.mndnr.gov/invasives/contacts.html. A list of designated infested waters is available at www.mndnr.gov/invasives/ais/infested.html. A list of prohibited invasive species is available at www.mndnr.gov/invasives/laws.html#prohibited.

CONSTRUCTION DEWATERING - GENERAL: All construction dewatering in excess of 10,000 gallons per day or one million gallons per year must be authorized by a separate water appropriation permit. All worksite discharge water must be treated for sediment reduction prior to return to the surface water. Water from designated infested waters shall not be diverted to other waters, transported on a public road, or transported or appropriated off property riparian to infested waters without a DNR permit specifically for this use. All equipment in contact with infested waters must be decontaminated upon leaving the site.

EROSION AND SEDIMENT CONTROL: In all cases, methods that have been determined to be the most effective and practical means of preventing or reducing sediment from leaving the worksite shall be installed in areas that slope to the water and on worksite areas that have the potential for direct discharge due to pumping or draining of areas from within the worksite (e.g., coffer dams, temporary ponds, stormwater inlets). These methods, such as mulches, erosion control blankets, temporary coverings, silt fence, silt curtains or barriers, vegetation preservation, redundant methods, isolation of flow, or other engineering practices, shall be installed concurrently or within 24 hours after the start of the project, and will be maintained for the duration of the project in order to prevent sediment from leaving the worksite. DNR requirements may be waived in writing by the authorized DNR staff based on site conditions, expected weather conditions, or project completion timelines.

GENERAL PERMIT CONDITIONS (Continued from previous page)

EXCAVATED MATERIALS - FLOODPLAIN CONCERN: Excavated material shall not be permanently placed within community designated floodplain areas or shoreland areas, unless all necessary local permits and approvals have been obtained.

AQUATIC PLANT MANAGEMENT: For projects where vegetation is placed waterward of the ordinary high water level, a separate Aquatic Plant Management (APM) permit is needed from the DNR Regional APM Specialist. See contact list at: <http://www.dnr.state.mn.us/apm/index.html>. A permit shall be obtained (no fee required) for each site in order to monitor plant source, species, and planting location. Vegetation must be appropriate for the site and free of invasive species. This condition does not apply when only woody vegetation is used, such as willow and dogwood.

APPLICABLE PROJECTS: A project not meeting applicable conditions of this permit or a project the DNR identifies as having the potential for significant resource impacts, is not authorized herein. Rather, such projects will require an individual DNR permit application.

ENVIRONMENTAL REVIEW: If the project proposal is part of a project that requires mandatory environmental review pursuant to MN Environmental Quality Board rules, then the permit is not valid until environmental review is completed.

RETAINING WALLS: Retaining walls are generally discouraged because their impact on the near-shore aquatic environment can be severe and they restrict wildlife movement, however, they may be permitted if the following conditions are met: a. Existing or expected erosion problems shall preclude the use of riprap shore protection with a finished slope of 2:1 (horizontal to vertical) or more gentle, due to steep banks, nearby structures or other extenuating circumstances; or there shall be a demonstrated need for direct shoreland docking. b. Design shall be consistent with existing uses in the area. Examples are: riverfront commercial-industrial areas having existing structures of this nature, dense residential areas where similar retaining walls are common, or where barges are utilized to carry equipment and supplies. c. Adequate engineering studies shall be performed on foundation conditions, tiebacks, internal drainage, construction materials, and protection against flanking. d. The facility shall not be an aesthetic intrusion upon the area and is consistent with all applicable local, state, and federal management plans and programs for the water body. e. Encroachment below the ordinary high water elevation shall be limited to the absolute minimum necessary for construction.

ICE RIDGE REMOVAL: Ice ridge removal projects must meet the DNR "no permit required" conditions for ice ridge removal specified in Minn. Rules part 6115.0215, Subpart 4. If not, a DNR Individual permit is required as District rules do not address this category of project.

HYDROLOGIC / HYDRAULIC DATA REPORTING :: Unless waived by the DNR Area Hydrologist, hydrologic modeling to show the impacts of a bridge or culvert constructed in a Public Water to the 100-year flood elevation is required. Additional modeling may also be required for temporary fill or temporary structures required during demolition or construction. Calculations showing calculated velocities through the structures at 2-year peak flows may also be required.

FISHERY PROTECTION - EXCLUSION DATES: No activity affecting the bed of the protected water may be conducted between March 15 and April 15 on watercourses, or between April 1 and June 30 on all other waterbodies, to minimize impacts on fish spawning and migration. If work during this time is essential, it shall be done only upon written approval of the Area Fisheries Manager. See contact list at:

http://files.dnr.state.mn.us/fisheries/management/dnr_fisheries_managers.pdf Should work begin elsewhere in the project area within these dates, all exposed soils that are within 200 feet of Public Waters and drain to those waters must complete erosion control measures within 24 hours of its disturbance to prevent sediment from entering Public Waters.

REPORTING: The Riley-Purgatory-Bluff Creek Watershed District shall submit annually or as requested a summary report of the projects authorized under this General Permit to the Area Hydrologist.

CONSTRUCTION AIDS: No construction is allowed of temporary channel diversions or placement of fill for temporary work pads, bypass roads, access roads, or coffer dams to aid in the construction of any authorized structure unless approved in writing by the Area Hydrologist prior to beginning work.

FISH PASSAGE: Bridges, culverts and other crossings shall provide for fish movement unless the structure is intended to impede rough fish movement or the stream has negligible fisheries value as determined by the DNR Area Hydrologist in consultation with the Area Fisheries Manager. The accepted practices for achieving these conditions include: Where possible a single culvert or bridge shall span the natural bankfull width adequate to allow for debris and sediment transport rates to closely resemble those of upstream and downstream conditions. A single culvert shall be recessed in order to pass bedload and sediment load. Additional culvert inverts should be set at a higher elevation. All culverts should match the alignment and slope of the natural stream channel, and extend through the toe of the road side slope. "Where

GENERAL PERMIT CONDITIONS *(Continued from previous page)*

possible" means that other conditions may exist and could take precedence, such as unsuitable substrate, natural slope and background velocities, bedrock, flood control, 100 year flood elevations, wetland/lake level control elevations, local ditch elevations, and other adjacent features. Rock Rapids or other structures may be used to retrofit crossings to mimic natural conditions.

PHOTOS AND AS-BUILTS: Upon completion of the authorized work, the permittee may be required to submit a copy of established benchmarks, representative photographs, and may be required to provide as-built surveys of Public Watercourse crossing changes.

EXCAVATION OF PUBLIC WATERS: Excavation of Public Waters is authorized by this permit only when the proposed excavation is consistent with Minnesota Rules 6115.0200 and 6115.0201.

REMOVAL OF STRUCTURES: Removal of structures from public waters is authorized by this permit when the proposed removal is consistent with Minnesota Rules 6115.0211 subp. 8.

cc: John Gleason, EWR District Manager